



DEPARTMENT OF PERMITTING, ENVIRONMENT, AND REGULATORY
AFFAIRS (PERA)
BOARD AND CODE ADMINISTRATION DIVISION

NOTICE OF ACCEPTANCE (NOA)

MIAMI-DADE COUNTY
PRODUCT CONTROL SECTION
11805 SW 26 Street, Room 208
Miami, Florida 33175-2474
T (786) 315-2590 F (786) 315-2599

www.miamidade.gov/pera/

Efco Corporation

1000 County Road, P.O. Box 609
Monett, MO 65708-0609

SCOPE:

This NOA is being issued under the applicable rules and regulations governing the use of construction materials. The documentation submitted has been reviewed and accepted by Miami-Dade County PERA - Product Control Section to be used in Miami Dade County and other areas where allowed by the Authority Having Jurisdiction (AHJ).

This NOA shall not be valid after the expiration date stated below. The Miami-Dade County Product Control Section (In Miami Dade County) and/or the AHJ (in areas other than Miami Dade County) reserve the right to have this product or material tested for quality assurance purposes. If this product or material fails to perform in the accepted manner, the manufacturer will incur the expense of such testing and the AHJ may immediately revoke, modify, or suspend the use of such product or material within their jurisdiction. PERA reserves the right to revoke this acceptance, if it is determined by Miami-Dade County Product Control Section that this product or material fails to meet the requirements of the applicable building code.

This product is approved as described herein, and has been designed to comply with the Florida Building Code, including the High Velocity Hurricane Zone.

DESCRIPTION: Series 5600-6" Deep Frame - Aluminum Curtain Wall System - L.M.I.

APPROVAL DOCUMENT: Drawing No. 1090, titled "6" Deep Series 5600 Large Missile Impact Curtain Wall System", sheets 1 through 9 of 9, dated 02/06/02 with revision C1 dated 09/30/11, prepared by W.W. Schaefer Engineering & Consulting, P.A., signed and sealed by Warren W. Schaefer, P.E., bearing the Miami-Dade County Product Control Revision stamp with the Notice of Acceptance number and expiration date by the Miami-Dade County Product Control Section.

MISSILE IMPACT RATING: Large and Small Missile Impact Resistant

LABELING: Each unit shall bear a permanent label with the manufacturer's name or logo, city, state, model/series, and following statement: "Miami-Dade County Product Control Approved", unless otherwise noted herein.

RENEWAL of this NOA shall be considered after a renewal application has been filed and there has been no change in the applicable building code negatively affecting the performance of this product.

TERMINATION of this NOA will occur after the expiration date or if there has been a revision or change in the materials, use, and/or manufacture of the product or process. Misuse of this NOA as an endorsement of any product, for sales, advertising or any other purposes shall automatically terminate this NOA. Failure to comply with any section of this NOA shall be cause for termination and removal of NOA.

ADVERTISEMENT: The NOA number preceded by the words Miami-Dade County, Florida, and followed by the expiration date may be displayed in advertising literature. If any portion of the NOA is displayed, then it shall be done in its entirety.

INSPECTION: A copy of this entire NOA shall be provided to the user by the manufacturer or its distributors and shall be available for inspection at the job site at the request of the Building Official.

This NOA **revises and renews** NOA # 07-0305.05 and consists of this page 1 and evidence pages E-1, E-2, E-3, E-4, and E-5, as well as approval document mentioned above.

The submitted documentation was reviewed by **Manuel Perez, P.E.**

MIAMI-DADE COUNTY
APPROVED

NOA No. 11-1027.19
Expiration Date: June 27, 2017
Approval Date: February 16, 2012
Page 1

NOTICE OF ACCEPTANCE: EVIDENCE SUBMITTED

A. DRAWINGS

1. Manufacturer's die drawings and sections.
2. Drawing No. **1090**, titled "6" Deep Series 5600 Large Missile Impact Curtain Wall System", sheets 1 through 9 of 9, dated 02/06/02, with revision C1 dated 09/30/11, prepared by W.W. Schaefer Engineering & Consulting, P.A., signed and sealed by Warren W. Schaefer, P.E.

B. TESTS

1. Test reports on: 1) Air Infiltration Test, per FBC, TAS 202-94
2) Uniform Static Air Pressure Test, Loading per FBC, TAS 202-94
3) Water Resistance Test, per FBC, TAS 202-94
4) Small Missile Impact Test per FBC, TAS 201-94
5) Large Missile Impact Test per FBC, TAS 201-94
6) Cyclic Wind Pressure Loading per FBC, TAS 203-94
along with installation diagram of a multiple span EFCO S5600 - **8" deep** outsize glazed aluminum curtain wall system 202" wide x 341" high x 64" return, specimen # **1 (A-A1)**, Glass types: **1, 2, 4, 5, 6A & 8**, marked-up by Hurricane Test Laboratory, Inc. Test Report No. **HTL-0046-0413-01**, dated 2/16-19/01, signed and sealed by Vinu J. Abraham, P.E.
(Submitted under previous NOA# 05-1212.11)
2. Test reports on: 1) Uniform Static Air Pressure Test, Loading per FBC, TAS 202-94
2) Large Missile Impact Test per FBC, TAS 201-94
3) Cyclic Wind Pressure Loading per FBC, TAS 203-94
along with installation diagram of a single span EFCO S5600 - **8" deep** outsize glazed aluminum curtain wall system 181-1/2" wide x 150" high, specimen # **9 (B1)**, Glass types: **3 & 5**, marked-up by Hurricane Test Laboratory, Inc. Test Report No. **HTL-0046-0816-01**, dated 8/24-27/01, signed and sealed by Vinu J. Abraham, P.E.
(Submitted under previous NOA# 05-1212.11)
3. Test reports on: 1) Air Infiltration Test, per FBC, TAS 202-94
2) Uniform Static Air Pressure Test, Loading per FBC, TAS 202-94
3) Water Resistance Test, per FBC, TAS 202-94
4) Large Missile Impact Test per FBC, TAS 201-94
5) Cyclic Wind Pressure Loading per FBC, TAS 203-94
along with installation diagram of a single span EFCO S5600 - **8" deep** outsize glazed aluminum curtain wall system 181-1/2" wide x 121-3/4" high, specimen # **3 (B3)**, Glass types: **6 & 7**, marked-up by Hurricane Test Laboratory, Inc. Test Report No. **HTL-0046-0816-01**, dated 8/14-15/01, signed and sealed by Vinu J. Abraham, P.E.
(Submitted under previous NOA# 05-1212.11)



Manuel Perez, P.E.
Product Control Examiner
NOA No: 11-1027.19

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B. TESTS (CONTINUED)

4. Test reports on: 1) Uniform Static Air Pressure Test, Loading per FBC, TAS 202-94
2) Large Missile Impact Test per FBC, TAS 201-94
3) Cyclic Wind Pressure Loading per FBC, TAS 203-94
along with installation diagram of a single span EFCO S5600 – 7" **deep** outsize glazed aluminum curtain wall system 181-1/2" wide x 121-3/4" high, specimen # **6 (C)**, Glass types: **1, 3A & 4**, marked-up by Hurricane Test Laboratory, Inc. Test Report No. **HTL-0046-0413-01**, dated 4/26-27/01, signed and sealed by Vinu J. Abraham, P.E.
(Submitted under previous NOA# 05-1212.11)
5. Test reports on: 1) Uniform Static Air Pressure Test, Loading per FBC, TAS 202-94
2) Large Missile Impact Test per FBC, TAS 201-94
3) Cyclic Wind Pressure Loading per FBC, TAS 203-94
along with installation diagram of a single span EFCO S5600 – 6" **deep** outsize glazed aluminum curtain wall system 181-1/2" wide x 169-1/4" high, specimen # **2 (D)**, Glass types: **1, 4 & 5**, marked-up by Hurricane Test Laboratory, Inc. Test Report No. **HTL-0046-0816-01**, dated 8/13-16/01, signed and sealed by Vinu J. Abraham, P.E.
(Submitted under previous NOA# 05-1212.11)
6. Test reports on: 1) Uniform Static Air Pressure Test, Loading per FBC, TAS 202-94
2) Large Missile Impact Test per FBC, TAS 201-94
3) Cyclic Wind Pressure Loading per FBC, TAS 203-94
along with installation diagram of a single span EFCO S5600 – 8" **deep** outsize glazed aluminum curtain wall system 181-1/2" wide x 121-3/4" high, specimen # **4 (E)**, Glass type: **5**, marked-up by Hurricane Test Laboratory, Inc. Test Report No. **HTL-0046-0816-01**, dated 8/16-17/01, signed and sealed by Vinu J. Abraham, P.E.
(Submitted under previous NOA# 05-1212.11)
7. Test reports on: 1) Air Infiltration Test, per FBC, TAS 202-94
2) Uniform Static Air Pressure Test, Loading per FBC, TAS 202-94
3) Water Resistance Test, per FBC, TAS 202-94
4) Small Missile Impact Test per FBC, TAS 201-94
5) Cyclic Wind Pressure Loading per FBC, TAS 203-94
along with installation diagram of a single span EFCO S5600 – 8" **deep** outsize glazed aluminum curtain wall system 181-1/2" wide x 121-3/4" high, specimen # **1 (F)**, Glass type: **2**, marked-up by Hurricane Test Laboratory, Inc. Test Report No. **HTL-0046-0517-01**, dated 5/11-17/01, signed and sealed by Vinu J. Abraham, P.E.
(Submitted under previous NOA# 05-1212.11)


Manuel Perez, P.E.
Product Control Examiner

NOA No. 11-1027.19

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B. TESTS (CONTINUED)

8. Test reports on: 1) Air Infiltration Test, per FBC, TAS 202-94
2) Uniform Static Air Pressure Test, Loading per FBC, TAS 202-94
3) Water Resistance Test, per FBC, TAS 202-94
4) Small Missile Impact Test per FBC, TAS 201-94
5) Large Missile Impact Test per FBC, TAS 201-94
6) Cyclic Wind Pressure Loading per FBC, TAS 203-94
along with installation diagram of a single span EFCO S5600 – 8" deep outsize glazed aluminum curtain wall system 181-1/2" wide x 116" high, specimen # **5 (G)**, Glass types: **2, 4 & 5**, marked-up by Hurricane Test Laboratory, Inc. Test Report No. **HTL-0046-0816-01**, dated 8/20/01, signed and sealed by Vinu J. Abraham, P.E.
(Submitted under previous NOA# 05-1212.11)
9. Test reports on: 1) Uniform Static Air Pressure Test, Loading per FBC, TAS 202-94
2) Large Missile Impact Test per FBC, TAS 201-94
3) Small Missile Impact Test per FBC, TAS 201-94
4) Cyclic Wind Pressure Loading per FBC, TAS 203-94
along with installation diagram of a single span EFCO S5600 – 8" deep outsize glazed aluminum curtain wall system 181-1/2" wide x 150" high, specimen # **6b (H)**, Glass types: **2, 4 & 5**, marked-up by Hurricane Test Laboratory, Inc. Test Report No. **HTL-0046-0816-01**, dated 8/21-23/01, signed and sealed by Vinu J. Abraham, P.E.
(Submitted under previous NOA# 05-1212.11)
10. Test reports on: 1) Uniform Static Air Pressure Test, Loading per FBC, TAS 202-94
2) Large Missile Impact Test per FBC, TAS 201-94
3) Small Missile Impact Test per FBC, TAS 201-94
4) Cyclic Wind Pressure Loading per FBC, TAS 203-94
along with installation diagram of a single span EFCO S5600 – 6" deep outsize glazed aluminum curtain wall system 181-1/2" wide x 98" high, specimen # **8 (J)**, Glass types: **1, 2 & 5**, marked-up by Hurricane Test Laboratory, Inc. Test Report No. **HTL-0046-0816-01**, dated 8/23-24/01, signed and sealed by Vinu J. Abraham, P.E.
(Submitted under previous NOA# 05-1212.11)
11. Test reports on: 1) Uniform Static Air Pressure Test, Loading per FBC, TAS 202-94
2) Large Missile Impact Test per FBC, TAS 201-94
3) Small Missile Impact Test per FBC, TAS 201-94
4) Cyclic Wind Pressure Loading per FBC, TAS 203-94
along with installation diagram of a single span EFCO S5600 – 8" deep outsize glazed aluminum curtain wall system 181-1/2" wide x 150" high, specimen # **6a (K)**, Glass types: **2, 4 & 5**, marked-up by Hurricane Test Laboratory, Inc. Test Report No. **HTL-0046-0816-01**, dated 8/21-23/01, signed and sealed by Vinu J. Abraham, P.E.
(Submitted under previous NOA# 05-1212.11)



Manuel Perez, P.E.
Product Control Examiner
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B. TESTS (CONTINUED)

12. Test reports on: 1) Air Infiltration Test, per FBC, TAS 202-94
2) Uniform Static Air Pressure Test, Loading per FBC, TAS 202-94
3) Water Resistance Test, per FBC, TAS 202-94
4) Large Missile Impact Test per FBC, TAS 201-94
5) Cyclic Wind Pressure Loading per FBC, TAS 203-94
along with installation diagram of a single span EFCO S5600 – 6” deep outsize glazed aluminum curtain wall system 181-1/2” wide x 112” high, specimen # 7 (L), Glass type: 5, marked-up by Hurricane Test Laboratory, Inc. Test Report No. HTL-0046-0816-01, dated 8/21-22/01, signed and sealed by Vinu J. Abraham, P.E.
(Submitted under previous NOA# 05-1212.11)
13. Test reports on: 1) Uniform Static Air Pressure Test, Loading per FBC, TAS 202-94
2) Large Missile Impact Test per FBC, TAS 201-94
3) Cyclic Wind Pressure Loading per FBC, TAS 203-94
along with installation diagram of a single span EFCO S5600 – 8” deep outsize glazed aluminum curtain wall system 181-1/2” wide x 121-3/4” high, specimen # 1 (M), Glass type: 6a, marked-up by Hurricane Test Laboratory, Inc. Test Report No. HTL-0046-1004-01, dated 10/17/01, signed and sealed by Vinu J. Abraham, P.E.
(Submitted under previous NOA# 05-1212.11)
14. Test reports on: 1) Uniform Static Air Pressure Test, Loading per FBC, TAS 202-94
2) Large Missile Impact Test per FBC, TAS 201-94
3) Cyclic Wind Pressure Loading per FBC, TAS 203-94
along with installation diagram of a three-bay specimen of a series S5600 8” deep outside glazed curtain wall system, 176” wide x 128-1/2” high, specimen #1; prepared by Hurricane Test Laboratory, Test Report No. HTL-0046-1019-03, Elevation A, dated 10/20/03, signed and sealed by Vinu J. Abraham, P.E.
(Submitted under previous NOA# 05-1212.11)
15. Test reports on: 1) Uniform Static Air Pressure Test, Loading per FBC, TAS 202-94
2) Large Missile Impact Test per FBC, TAS 201-94
3) Cyclic Wind Pressure Loading per FBC, TAS 203-94
along with installation diagram of a three-bay specimen of a series S5600 6” deep outside glazed curtain wall system, 182-1/2” wide x 98” high, specimen #2; prepared by Hurricane Test Laboratory, Test Report No. HTL-0046-0113-04, Elevation C, dated 01/09-12/04, signed and sealed by Vinu J. Abraham, P.E.
(Submitted under previous NOA# 05-1212.11)


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Product Control Examiner

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C. CALCULATIONS:

1. Anchor verification calculations and structural analysis, complying with FBC-2007 and 2010, dated 08/31/06, and revised and updated on 09/29/11, prepared by W.W. Schaefer Engineering & Consulting, P.A., signed and sealed by Warren W. Schaefer, P.E.
2. Glazing complies with ASTM E1300-04

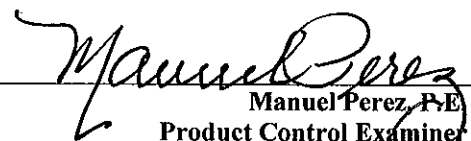D. QUALITY ASSURANCE

1. Miami-Dade Department of Permitting, Environment, and Regulatory Affairs (PERA).

E. MATERIAL CERTIFICATIONS


1. Notice of Acceptance No. **11-0624.02** issued to **E.I. DuPont DeNemours & Co., Inc.** for their "**DuPont SentryGlas® Interlayer**" dated 08/25/11, expiring on 01/14/17.
2. Notice of Acceptance No. **07-1116.11** issued to **Saf-Glas, LLC** for their "**SAF-GLAS Polycarbonate Laminate**", dated 12/27/07, expiring on 12/16/12.
3. Notice of Acceptance No. **08-0508.02** issued to **Viracon, Inc.** for their "**StormGuard Glass Interlayer**", dated 07/03/08, expiring on 04/14/13.
4. Notice of Acceptance No. **08-1118.07** issued to **Oldcastle Glass Inc.** for their "**StormGlass Glass Interlayer**", dated 03/05/09, expiring on 12/11/13.


F. STATEMENTS

1. Statement letter of conformance, complying with FBC-2007 and FBC-2010, dated 09/28/11, signed and sealed by Warren W. Schaefer, P.E.
2. Statement letter of no financial interest, dated 09/28/11, signed and sealed by Warren W. Schaefer, P.E.
3. Laboratory compliance letter for Test Reports No. **HTL-0046-0413-01, HTL-0046-0517-01 & HTL-0046-0816-01** issued by Hurricane Test Laboratory, Inc., dated October 23, 2001, signed and sealed by Vinu J. Abraham, P.E.
(Submitted under previous NOA # 05-1212.11)
4. Proposal No. **01-0092**, acceptance letter dated July 30, 2001, issued by this Office and signed by Jaime D. Gascon.
(Submitted under previous NOA # 05-1212.11)

G. OTHERS

1. Notice of Acceptance No. **07-0305.05**, issued to EFCO Corporation for their Series 5600 – 6" Deep Frame - Aluminum Curtain Wall System – L.M.I., approved on 05/10/07 and expiring on 06/27/12.

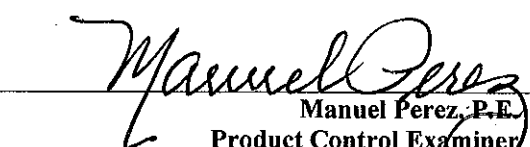
Manuel Perez, P.E.
Product Control Examiner
NOA No. 11-1027.19
Expiration Date: June 27, 2017
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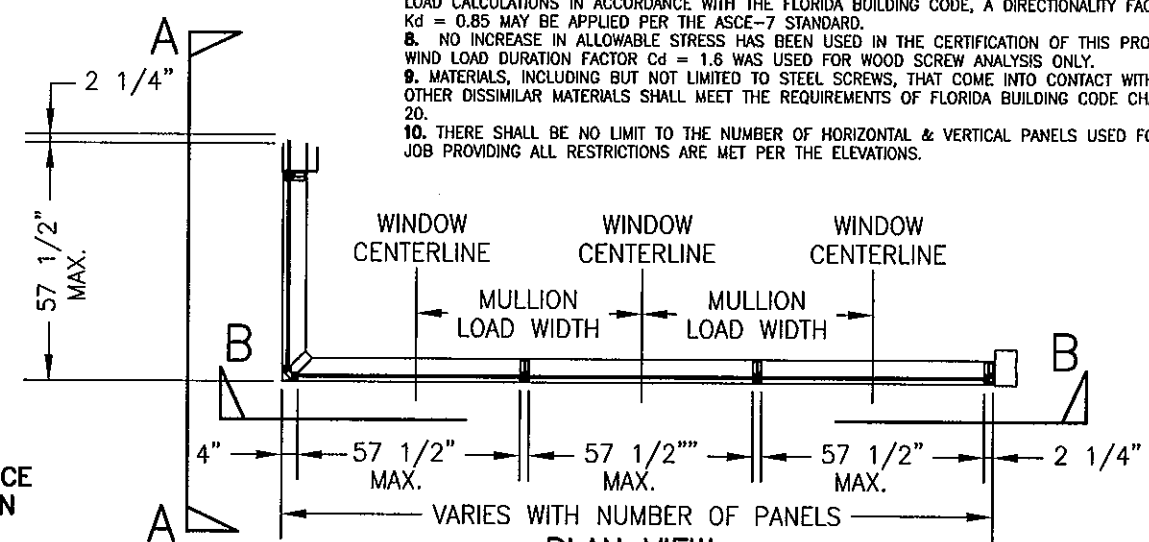
VIEW "A-A"
(EXTERIOR ELEVATION)
ONLY ONE ROW SHOWN; MORE THAN ONE ROW MAY BE INSTALLED

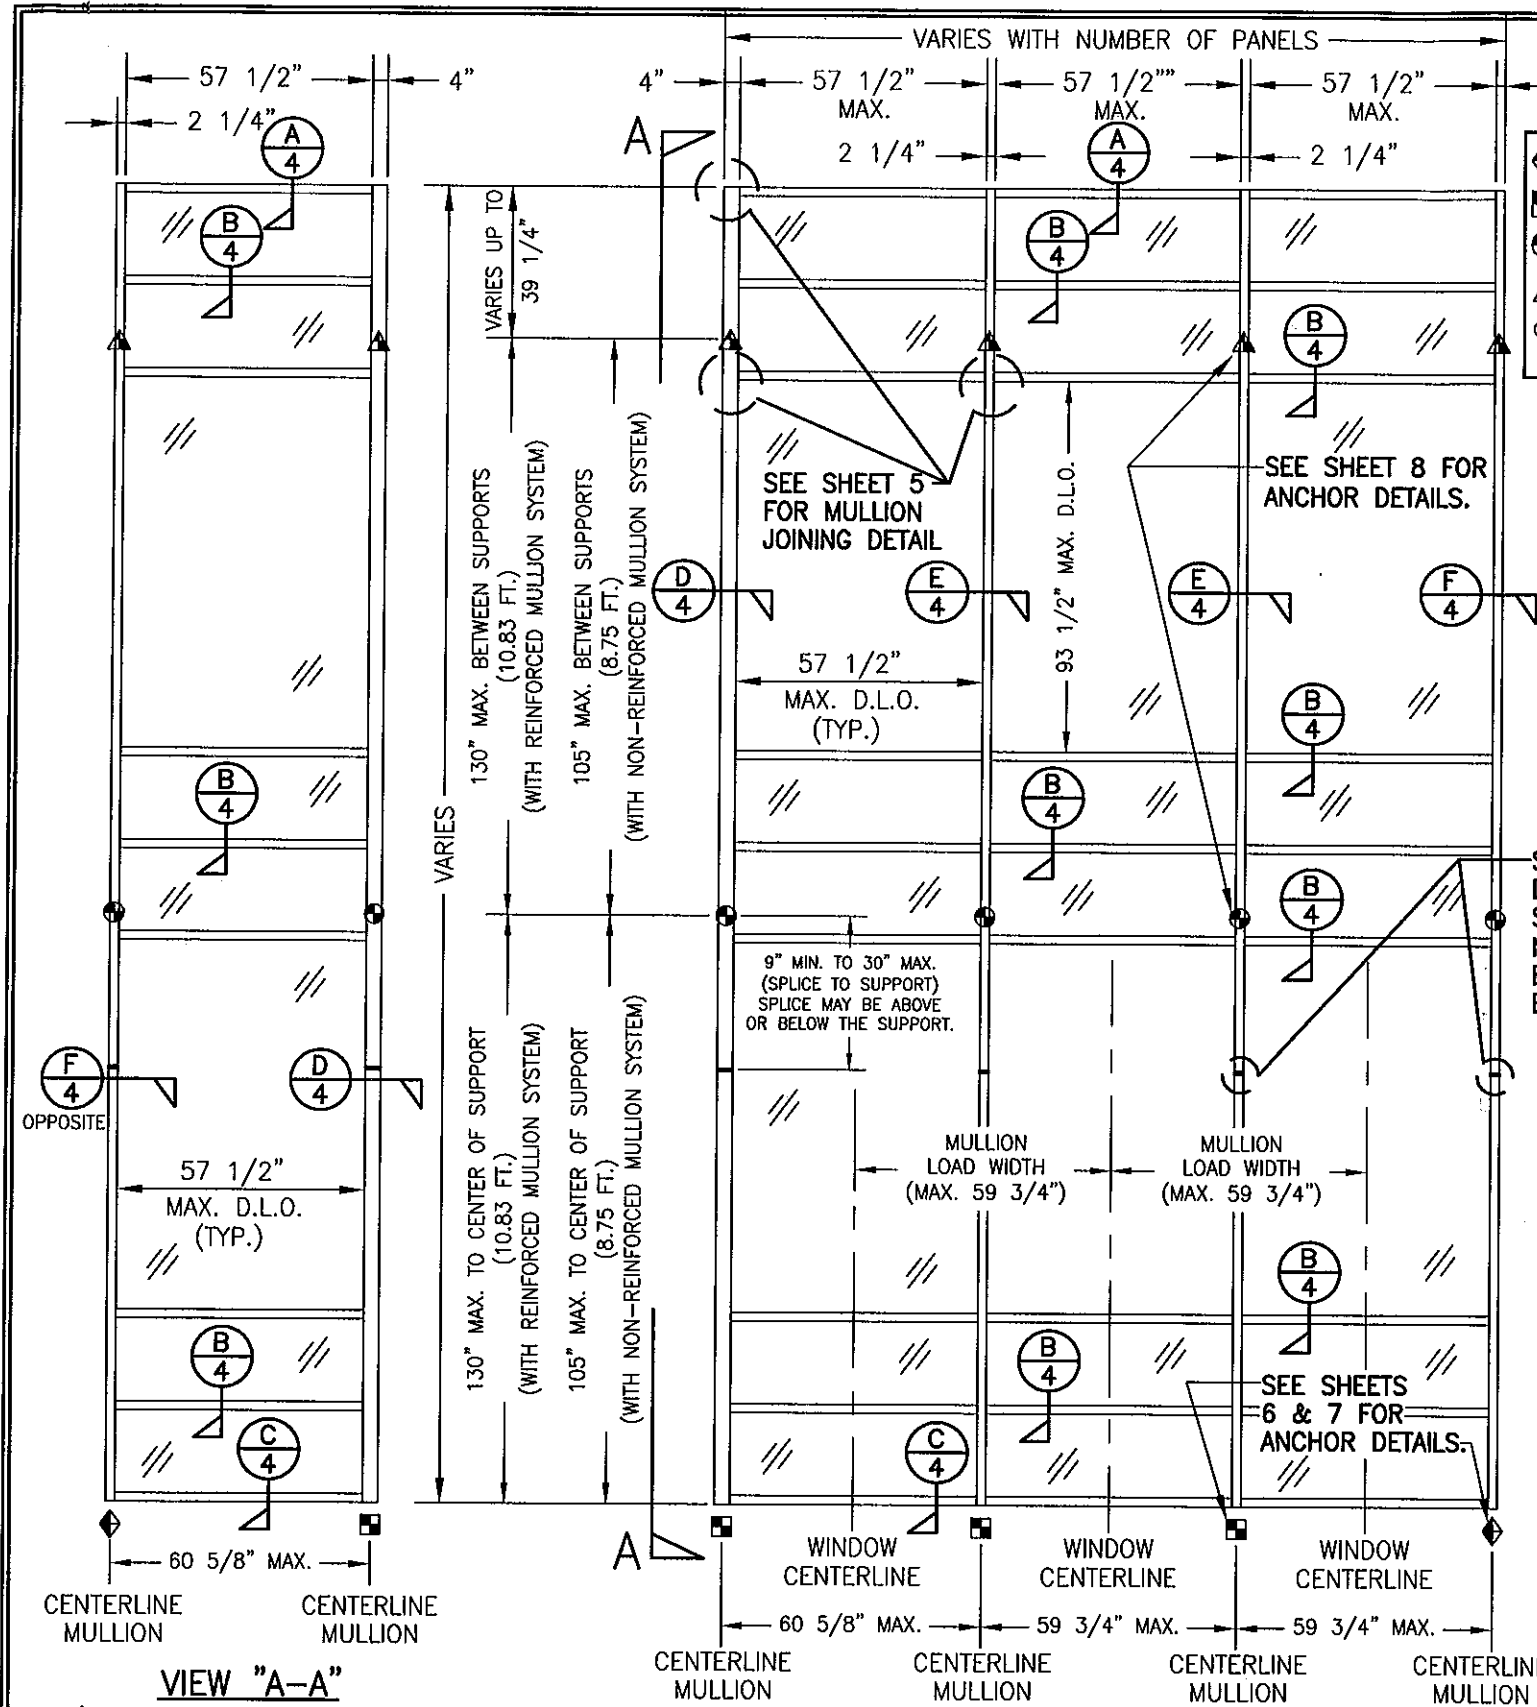THESE DRAWINGS ARE APPLICABLE ONLY TO THE PRODUCT SPECIFIED. THEY MAY NOT BE USED FOR THE ASSEMBLY AND/OR INSTALLATION OF ANY OTHER PRODUCT NOR MAY THEY BE USED FOR RATIONAL AND/OR LOCAL APPROVAL OF ANY PRODUCT NOT PRODUCED BY THE MANUFACTURER STATED ON THESE DRAWINGS.

EXTERIOR ELEVATION: VIEW "B-B"
CURTAIN WALL WITH MULTIPLE VERTICAL SPANS
SCALE: N.T.S.

NOTE: THIS ELEVATION SHOWS THE 5600 CURTAIN WALL SYSTEM IN A MULTI-STORY APPLICATION. THE NUMBER OF FLOORS WITH WHICH THIS SYSTEM MAY BE USED RANGE FROM TWO(2) TO UNLIMITED WITH THE ONLY RESTRICTIONS BEING AS SHOWN ON THE SPAN BETWEEN FLOORS/SUPPORTS AND THE D.L.O. SIZE

- ◆ = F OR TF-ANCHOR
- = M OR TM-ANCHOR
- ⊙ = DEAD LOAD ANCHOR
- ▲ = WIND LOAD ANCHOR
- ⊛ = DOOR JAMB MULLION SHEAR BLOCK ANCHOR



PLAN VIEW
CURTAIN WALL WITH MULTIPLE VERTICAL SPANS
SCALE: 1/4"=1'-0"


"F", "TF", "M", "TM" & SHEAR BLOCK ANCHOR FASTENER REQUIREMENTS TABLE

OPENING TYPE (SUBSTRATE)	ANCHOR TO OPENING FASTENER TYPE	NO. FASTENERS PER ANCHOR INTO SUBSTRATE		MINIMUM EMBED	EDGE DIST.
		SHEAR BLOCK ANCHORS	F, TF, M & TM ANCHORS		
MIN. 16 GA. 33 KSI METAL STUD	(1) NO. 14 SELF TAP/DRILLING SCREW	3	4	FULL	1/2"
MIN. 1/8" THK A36 STEEL	(1) NO. 14 SELF TAP/DRILLING SCREW	3	4	FULL	1/2"
MIN. 3000 PSI CONCRETE	(2) 3/8" ADHESIVE ANCHORS	N/A	4	3 1/2"	3"
MIN. 3000 PSI CONCRETE	(2) 1/2" ADHESIVE ANCHORS	2	N/A	4"	3"

- (1) SELF DRILLING/TAPPING SCREWS SHALL BE MIN. GR. 5 STEEL & BE COATED TO RESIST CORROSION & REACTIONS WITH DISSIMILAR MATERIALS.
- (2) ADHESIVE ANCHORS SHALL BE HILTI HVA ADHESIVE ANCHOR (A307, A36 OR ASTM A193 B7 STEEL OR 304/316 STAINLESS STEEL)

PRODUCT REVISED
as complying with the Florida
Building Code
Acceptance No 11-1027.19
Expiration Date June 27, 2017

By *Warren W. Schaefer*
Miami/Dade Product Control

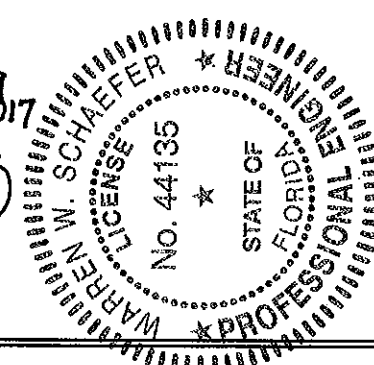

ALLOWABLE DESIGN LOADS
SEE LOAD TABLES ON SHEET 3

GENERAL NOTES:

1. THESE CURTAIN WALL SYSTEMS HAVE BEEN TESTED, ANALYZED & APPROVED FOR DESIGN PRESSURES NOT TO EXCEED THOSE SHOWN IN THE "ALLOWABLE DESIGN PRESSURE TABLE(S)".
2. OPENINGS, BUCKING & BUCKING FASTENERS MUST BE PROPERLY DESIGNED & INSTALLED TO TRANSFER WIND LOADS TO THE STRUCTURE.
3. ALL HARDWARE & FASTENERS SHALL BE IN ACCORDANCE WITH THESE DRAWINGS & SHALL NOT VARY UNLESS SPECIFICALLY MENTIONED ON THE DRAWINGS. SPECIFIED ANCHOR EMBED TO BASE MATERIAL SHALL BE BEYOND WALL FINISH OR STUCCO.
4. THE DETAILS & SPECIFICATIONS SHOWN HEREIN REPRESENT THE PRODUCTS TESTED & PROPOSED FOR WATER, AIR, IMPACT, CYCLIC & UNIFORM STATIC AIR PRESSURE TESTING IN CONFORMANCE WITH THE FLORIDA BUILDING CODE PROTOCOLS TAS-201, 202 & 203 FOR LARGE MISSILE IMPACT CURTAIN WALL SYSTEMS.
5. THESE CURTAIN WALL SYSTEMS HAVE BEEN DESIGNED IN ACCORDANCE WITH AND MEET THE REQUIREMENTS OF THE FLORIDA BUILDING CODE (FBC) INCLUDING HIGH VELOCITY HURRICANE ZONES (HVHZ).
6. IMPACT SHUTTERS ARE NOT REQUIRED WITH THESE STORE FRONT SYSTEMS.
7. DETERMINE THE POSITIVE & NEGATIVE DESIGN LOADS TO USE WHEN REFERENCING THESE DOCUMENTS IN ACCORDANCE WITH THE GOVERNING CODE AND GOVERNING WIND VELOCITY. FOR WIND LOAD CALCULATIONS IN ACCORDANCE WITH THE FLORIDA BUILDING CODE, A DIRECTIONALITY FACTOR OF Kd = 0.85 MAY BE APPLIED PER THE ASCE-7 STANDARD.
8. NO INCREASE IN ALLOWABLE STRESS HAS BEEN USED IN THE CERTIFICATION OF THIS PRODUCT. WIND LOAD DURATION FACTOR Cd = 1.6 WAS USED FOR WOOD SCREW ANALYSIS ONLY.
9. MATERIALS, INCLUDING BUT NOT LIMITED TO STEEL SCREWS, THAT COME INTO CONTACT WITH OTHER DISSIMILAR MATERIALS SHALL MEET THE REQUIREMENTS OF FLORIDA BUILDING CODE CHAPTER 20.
10. THERE SHALL BE NO LIMIT TO THE NUMBER OF HORIZONTAL & VERTICAL PANELS USED FOR ANY JOB PROVIDING ALL RESTRICTIONS ARE MET PER THE ELEVATIONS.

DRAWN BY: W.W.S.		CHECKED BY: W.W.S.	
PLOT: 1-48		DATE: 02/08/02	
DATE	BY	REVISION	DESCRIPTION
04/08/03	K.P.S.	A1	ADDED DOOR OPENING CONDITION & EDITED LOAD TABLES TO INCORPORATE DOOR CONDITION
07/27/05	K.P.S.	B1	UPDATE TO 2004 CODE
09/30/11	W.R.M.	C1	UPDATE TO CURRENT STANDARDS

DRAWING TITLE
6" DEEP SERIES 5600 LARGE MISSILE IMPACT CURTAIN WALL SYSTEM

MANUFACTURER
EFCO CORPORATION
1000 COUNTY ROAD, P.O. BOX 609
MONETT, MO 65708-0609
800-221-4169


CONSULTANTS
W. W. SCHAEFER ENGINEERING & CONSULTING, P.A. (CA 6809)
7480 150TH COURT NORTH
PALM BEACH GARDENS, FL 33418
PHONE: 561-744-3424

CERTIFICATION
SEP 30 2011
WARREN W. SCHAEFER, P.E.
P.E. NO. 44135

DRAWING NO.
1090

REV.
C


SHEET NO.
1 OF 9

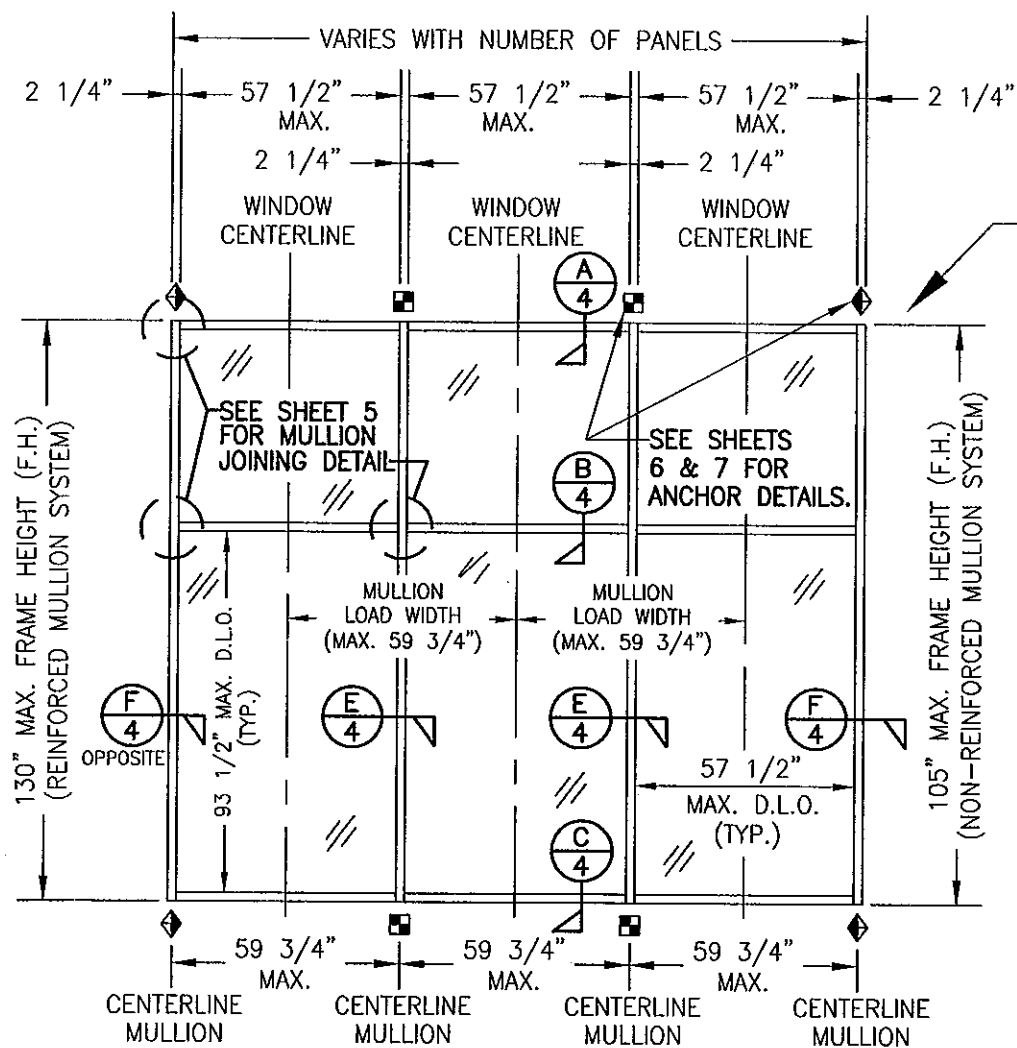

**EXTERIOR ELEVATION
CURTAIN WALL WITH SINGLE VERTICAL SPAN**
SCALE: 1/4"=1'-0"

NOTE: THIS ELEVATION SHOWS THE 5600 CURTAIN WALL SYSTEM IN A SINGLE SPAN APPLICATION. ALL SINGLE SPAN APPLICATIONS ARE LIMITED BY EACH THE D.L.O. SIZES OF THE LIGHTS & THE HEIGHT/SPAN SHOWN. IF REQUIRED HEIGHT EXCEEDS THAT SHOWN IN THIS ELEVATION, THE SYSTEM MUST BE SUPPORTED AS TWO OR MORE SPANS PER THE MULTIPLE SPAN ELEVATION.

NOTE: THE ELEVATIONS ON THIS SHEET MAY HAVE A 90 DEGREE TURN AS SHOWN ON SHEET 1 ELEVATION OF THE MULTI-SPAN SYSTEM. REF. VIEW "A-A" ON SHEET 1 FOR DETAIL.

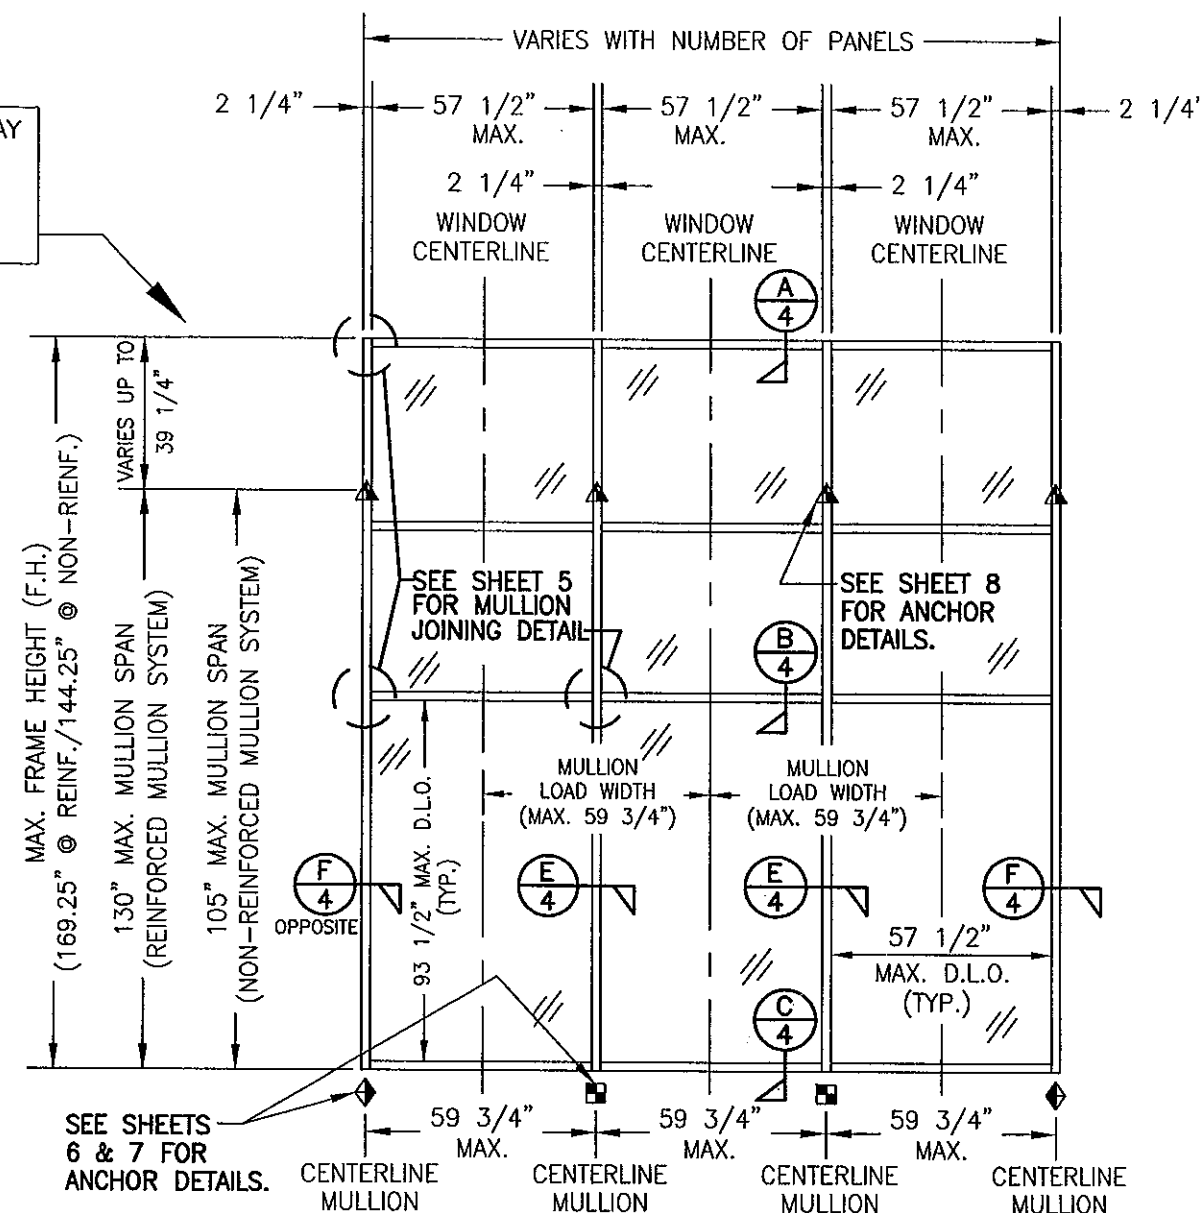


**EXTERIOR ELEVATION; CURTAIN WALL
WITH SINGLE VERTICAL SPAN AND CANTELEVER**
SCALE: 1/4"=1'-0"

NOTE: THIS ELEVATION SHOWS THE 5600 CURTAIN WALL SYSTEM IN A SINGLE SPAN APPLICATION. ALL SINGLE SPAN APPLICATIONS ARE LIMITED BY EACH THE D.L.O. SIZES OF THE LIGHTS & THE HEIGHT/SPAN SHOWN. IF REQUIRED HEIGHT EXCEEDS THAT SHOWN IN THIS ELEVATION, THE SYSTEM MUST BE SUPPORTED AS TWO OR MORE SPANS PER THE MULTIPLE SPAN ELEVATION.


- ◆ = F OR TF-ANCHOR
- = M OR TM-ANCHOR
- = DEAD LOAD ANCHOR
- ▲ = WIND LOAD ANCHOR
- ⊙ = DOOR JAMB MULLION SHEAR BLOCK ANCHOR

PRODUCT REVISED
as complying with the Florida
Building Code
Acceptance No. 11-1027-19
Expiration Date June 27, 2017
By *Manuel P. [Signature]*
Miami Dade Product Control

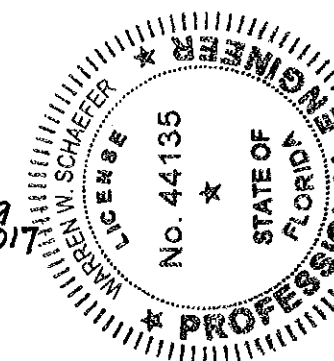

DRAWN BY: W.W.S.		CHECKED BY: W.W.S.	
PLOT: 1-48		DATE: 02/06/02	
DATE	BY	REVISION DESCRIPTION	NO.
DRAWING TITLE 6" DEEP SERIES 5600 LARGE MISSILE IMPACT CURTAIN WALL SYSTEM			
CONSULTANTS W. W. SCHAEFER ENGINEERING & CONSULTING, P.A. (CA 6809)		MANUFACTURER EFCO CORPORATION	
7480 150TH COURT NORTH PALM BEACH GARDENS, FL 33418 PHONE: 561-744-3424		1000 COUNTY ROAD, P.O. BOX 609 MONETT, MO 65708-0609 800-221-4169	
DRAWING NO. 1090		REV. C	
SHEET NO. 2		OF 9	


- ◆ = F OR TF-ANCHOR
- = M OR TM-ANCHOR
- = DEAD LOAD ANCHOR
- ▲ = WIND LOAD ANCHOR
- ⊙ = DOOR JAMB MULLION SHEAR BLOCK ANCHOR

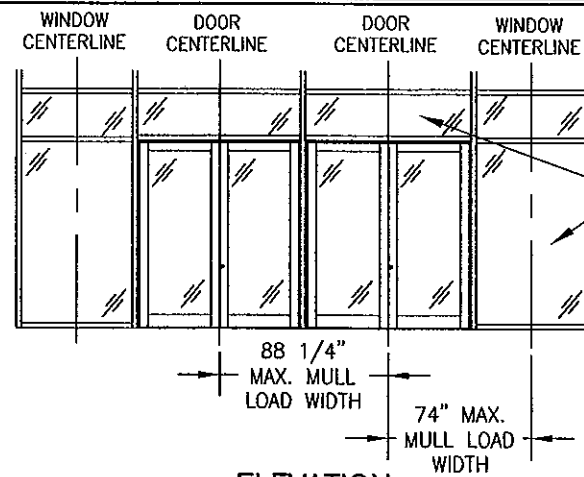

NOTE: ALL WINDOW D.L.O.'S ARE RESTRICTED BY THE 57.5" & 93.5" SHORT & LONG DIMENSIONS AS WITH THE OTHER ELEVATIONS

NOTE: CONDITIONS SHOWN ALSO APPLY TO SINGLE PANEL DOOR CONDITIONS.

ELEVATION
NOT TO SCALE
(2 SIDE BY SIDE DOUBLE DOORS IN CURTAIN WALL)

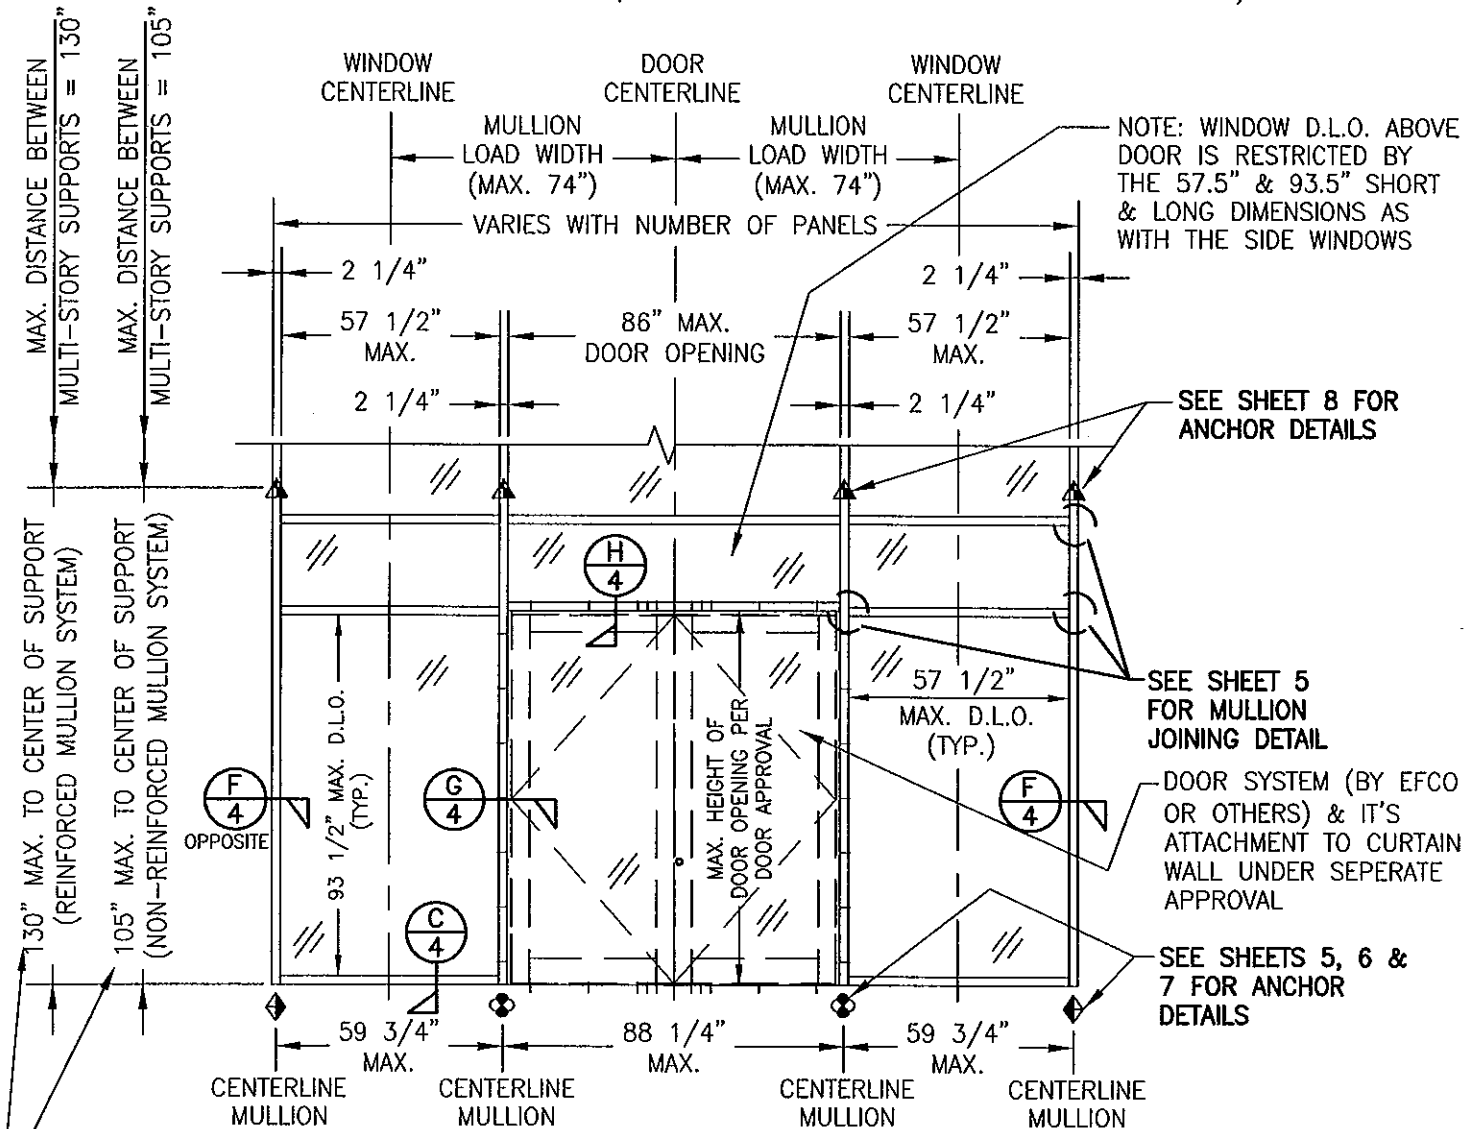

EXTERIOR ELEVATION
CURTAIN WALL WITH DOOR

SCALE: 1/4"=1'-0"

NOTE: THIS ELEVATION SHOWS THE 5600 CURTAIN WALL SYSTEM IN A MULTI-STORY APPLICATION WITH A DOOR OPENING. DIMENSIONAL RESTRICTIONS ARE AS SHOWN IN THE ELEVATION. FOR AREA ABOVE DOOR AND FOR SINGLE SPAN MULLION CONDITION, REFERENCE OTHER SECTIONS.


THIS DIMENSION ALSO APPLIES TO SINGLE VERTICAL SPAN CONDITION AS THE MAX. HEIGHT.

ALLOWABLE FRAMING DESIGN PRESSURES


WITHOUT REINFORCMENT IN MULLIONS			WITH REINFORCED VERTICAL MULLIONS		
VERTICAL DISTANCE BETWEEN SUPPORTS	MAXIMUM MULLION LOAD WIDTH	ALLOWABLE DESIGN LOAD	VERTICAL DISTANCE BETWEEN SUPPORTS	MAXIMUM MULLION LOAD WIDTH	ALLOWABLE DESIGN LOAD
		POSITIVE & NEGATIVE (PSF)			POSITIVE & NEGATIVE (PSF)
72" & LESS	59 3/4"	90.0	84" & LESS	74"	90.0
78"	48"	90.0		80"	89.6
	54"	87.3		88"	81.5
	59 3/4"	78.9		74"	90.0
84"	42"	90.0	90"	80"	83.7
	48"	84.7		88"	76.0
	54"	75.3		66"	90.0
	59 3/4"	68.1	96"	74"	84.8
	66"	61.6		80"	78.4
	74"	55.0		88"	71.3
	80"	50.8		59 3/4"	90.0
	90"	88"	46.2	104"	66"
36"		90.0	74"		78.3
42"		84.3	80"		72.4
48"		73.8	88"		65.8
54"		65.6	112"	59 3/4"	90.0
59 3/4"		59.3		66"	81.5
66"		53.7		74"	72.7
74"		47.9		80"	67.2
98"	80"	44.3	120"	88"	61.1
	88"	40.3		48"	90.0
	30"	90.0		54"	81.0
	36"	83.0		59 3/4"	73.2
	42"	71.1	66"	66.2	
	48"	62.2	74"	59.1	
	54"	55.3	80"	54.7	
	59 3/4"	50.0	88"	49.7	
	66"	45.3	126"	42"	90.0
	74"	40.4		48"	78.7
80"	37.3	54"		69.9	
88"	33.9	59 3/4"		63.2	
105"	24"	90.0	130"	66"	57.2
	30"	81.0		74"	51.0
	36"	67.5		80"	47.2
	42"	57.8		88"	42.9
	48"	50.6		36"	90.0
	54"	45.0		42"	81.9
	59 3/4"	40.7		48"	71.6
	66"	36.8		54"	63.7
	74"	32.8		59 3/4"	57.6
	80"	30.4		66"	52.1
88"	27.6	74"	46.5		
1. THE LOADS IN THIS TABLE ARE APPLICABLE FOR SINGLE & MULTI SPAN SYSTEMS			80"	43.0	
			88"	39.1	


1. THE LOADS IN THIS TABLE ARE APPLICABLE FOR SINGLE & MULTI SPAN SYSTEMS.
2. REGARDLESS OF LOAD WIDTHS SPECIFIED IN THIS TABLE, THE D.L.O. OF FIXED GLASS PANELS MAY NOT EXCEED 57 1/2" IN THEIR SHORT SIDE DIMENSION NOR 93 1/2" IN THEIR LONG SIDE DIMENSION.

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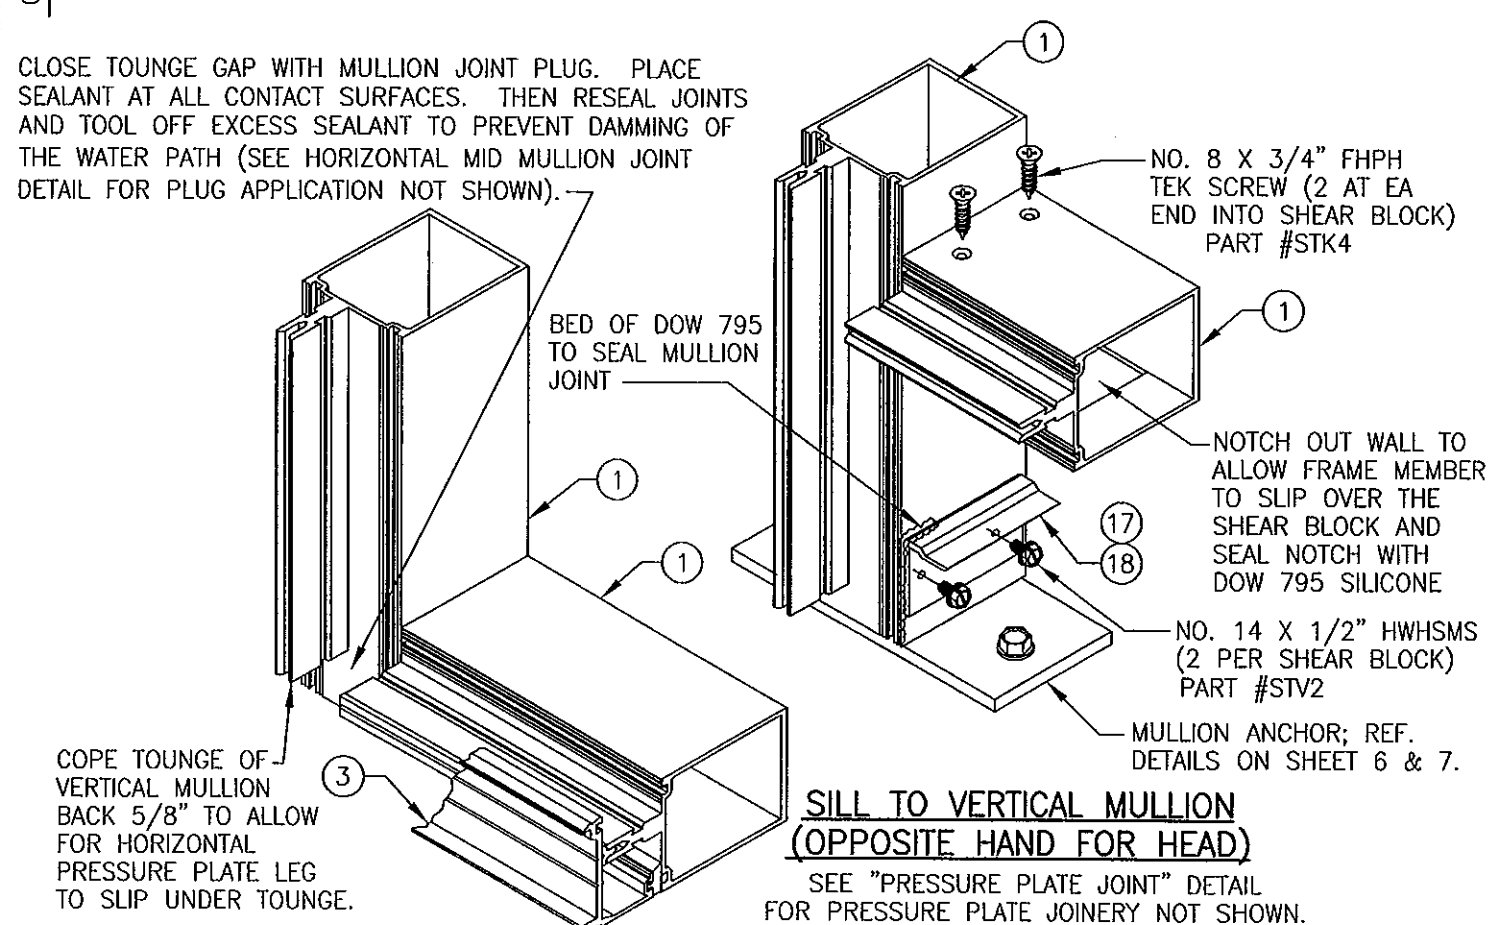
DRAWN BY: W.W.S.		CHECKED BY: W.W.S.	
PLOT: 1-48		DATE: 02/06/02	
NO.	REVISION DESCRIPTION	DATE	BY
DRAWING TITLE: 6" DEEP SERIES 5600 LARGE MISSILE IMPACT CURTAIN WALL SYSTEM			
CONSULTANTS: W. W. SCHAEFER ENGINEERING & CONSULTING, P.A. (CA 6809)		MANUFACTURER: EFCO CORPORATION	
7480 150TH COURT NORTH PALM BEACH GARDENS, FL 33418		1000 COUNTY ROAD, P.O. BOX 609 MONETT, MO 65708-0609	
PHONE: 561-744-3424		800-221-4169	
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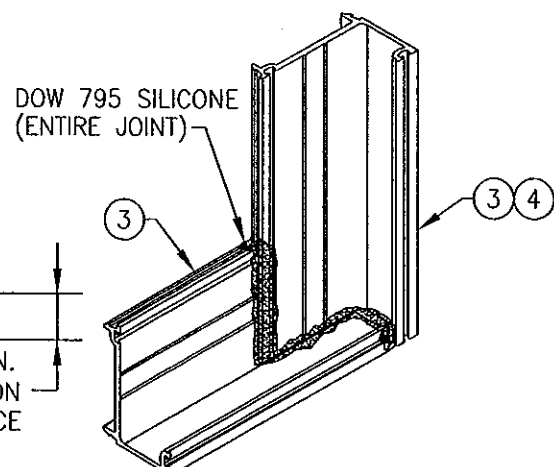
MULLION SPLICE DETAIL

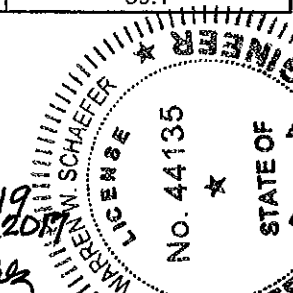CLOSE TOUNGE GAP WITH MULLION JOINT PLUG. PLACE SEALANT AT ALL CONTACT SURFACES. THEN RESEAL JOINTS AND TOOL OFF EXCESS SEALANT TO PREVENT DAMMING OF THE WATER PATH (SEE HORIZONTAL MID MULLION JOINT DETAIL FOR PLUG APPLICATION NOT SHOWN).

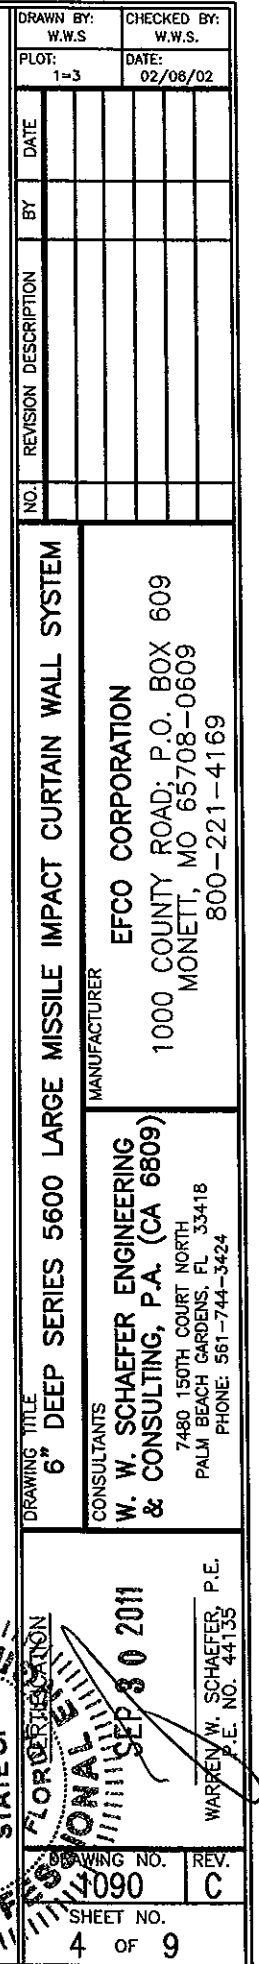


**SILL TO VERTICAL MULLION
(OPPOSITE HAND FOR HEAD)**

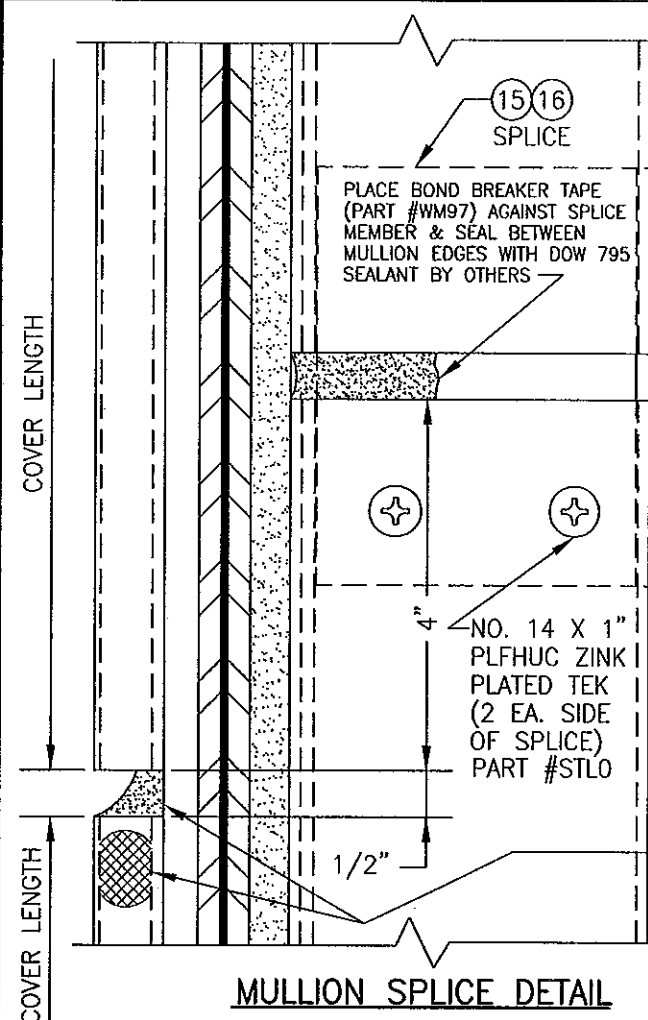SEE "PRESSURE PLATE JOINT" DETAIL FOR PRESSURE PLATE JOINERY NOT SHOWN.




**PRESSURE PLATE JOINT
(TYP. AT CORNERS)**


SIMILAR AT MID MULLION ENDS EXCEPT THAT THE HORIZONTAL PRESSURE PLATES SEAM TOGETHER AT THE MULLION CENTERLINE WITH A 1/8" SEAM SEALED WITH DOW 795 SILICONE.

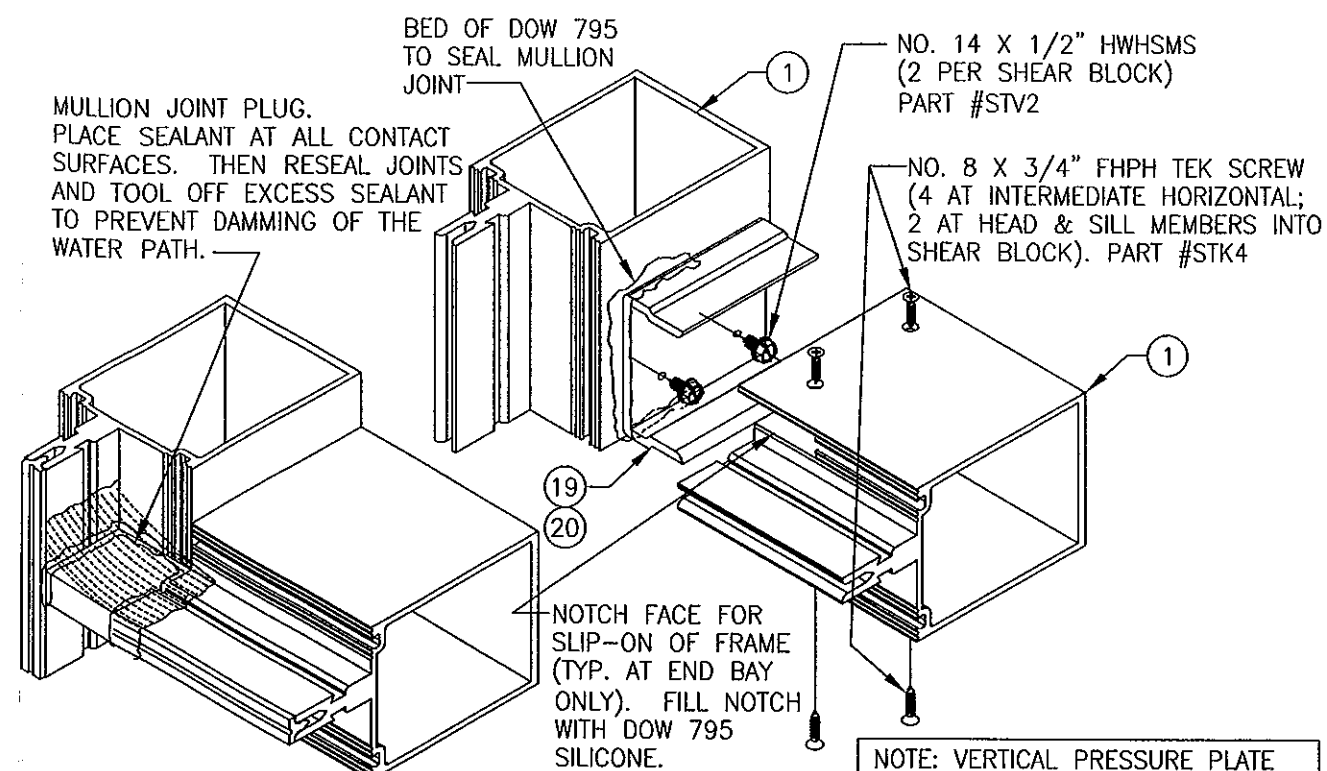


**HORIZONTAL MID MULLION
TO VERTICAL MULLION**

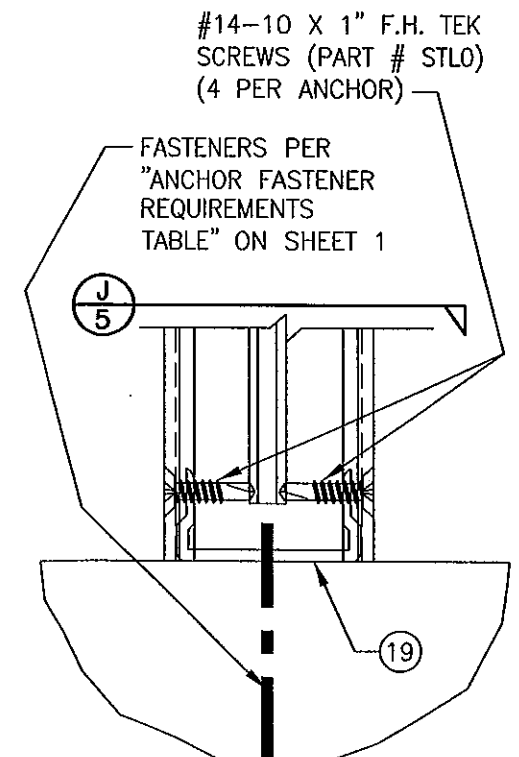

NOTE: GLAZING & HORIZONTAL MEMBERS NOT SHOWN FOR CLARITY.

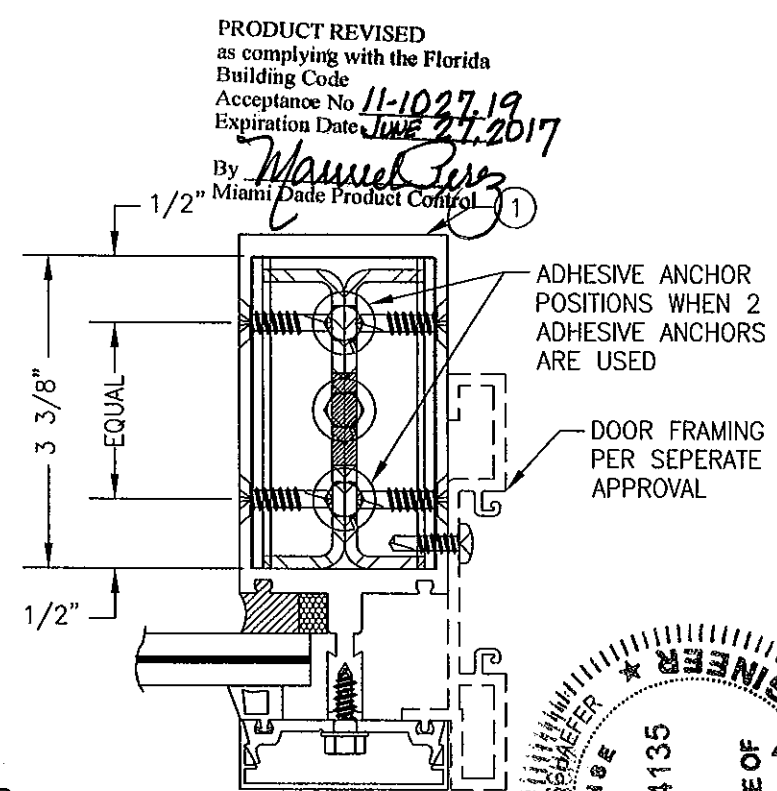

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Miami Dade Product Control

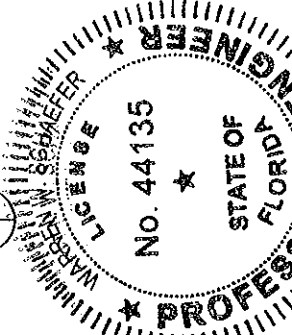

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PLOT: 1-2		DATE: 02/06/02	
NO.	DATE	BY	REVISION DESCRIPTION
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DRAWING TITLE
6" DEEP SERIES 5600 LARGE MISSILE IMPACT CURTAIN WALL SYSTEM

MANUFACTURER
EFCO CORPORATION
1000 COUNTY ROAD, P.O. BOX 609
MONETT, MO 65708-0609
800-221-4169







CONSULTANTS
W. W. SCHAEFER ENGINEERING & CONSULTING, P.A. (CA 6809)
7480 150TH COURT NORTH
PALM BEACH GARDENS, FL 33418
PHONE: 561-744-3424

DATE
SEP 30 2011

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1090

SHEET NO.
5 OF 9

REV.
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DRAWN BY: W.W.S.		CHECKED BY: W.W.S.	
PLOT: 1=2		DATE: 02/06/02	
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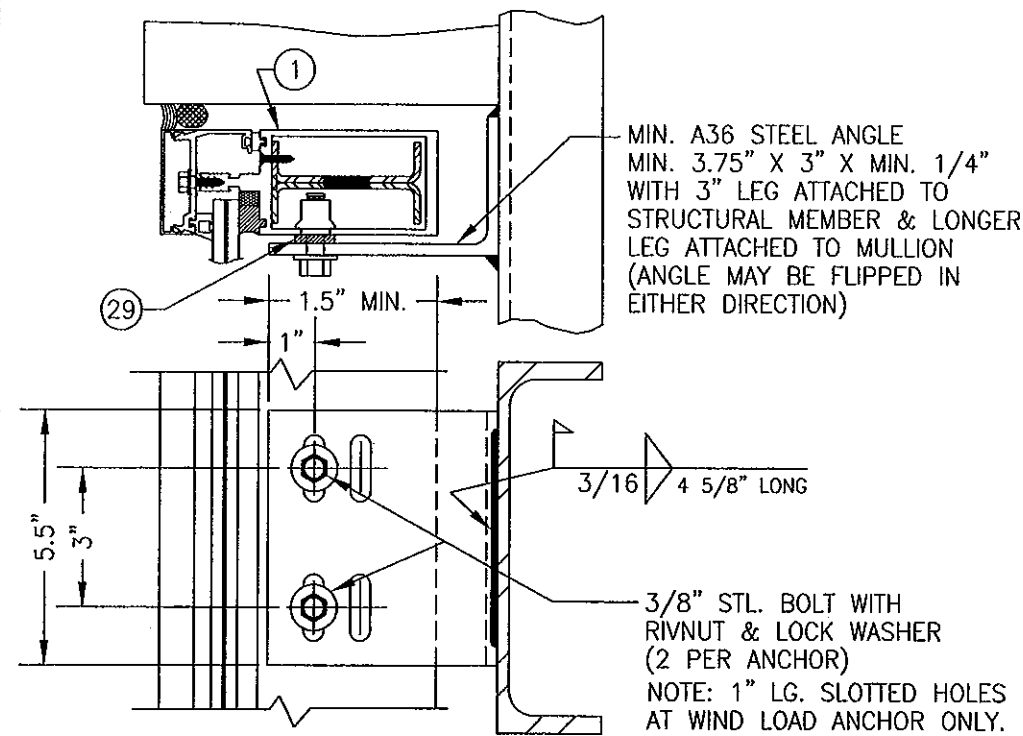
DATE
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REVISION
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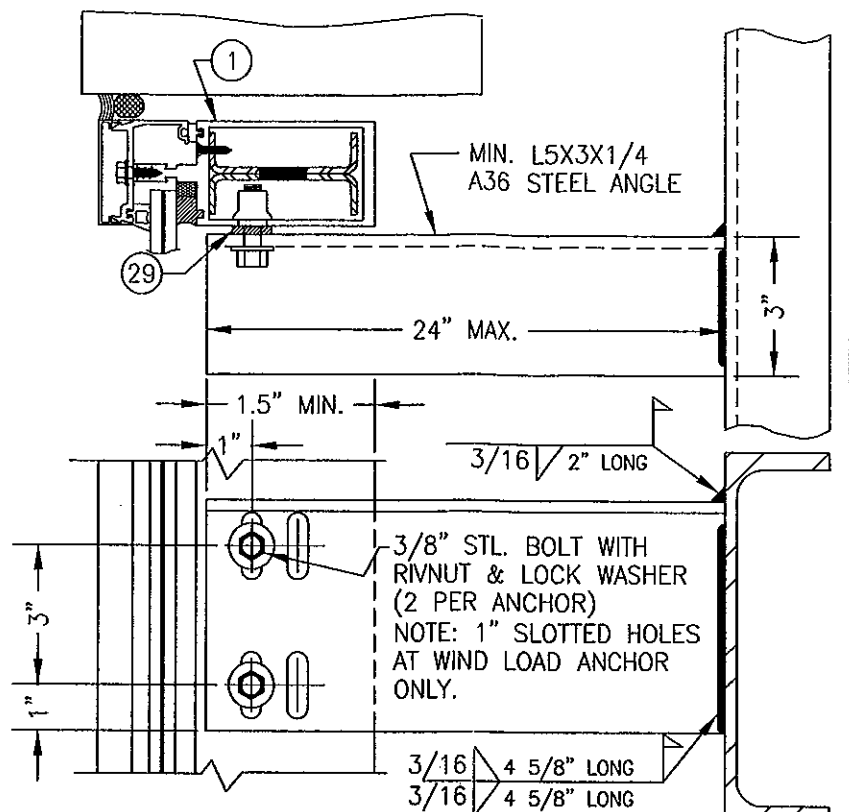
SHEET NO.
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Building Code
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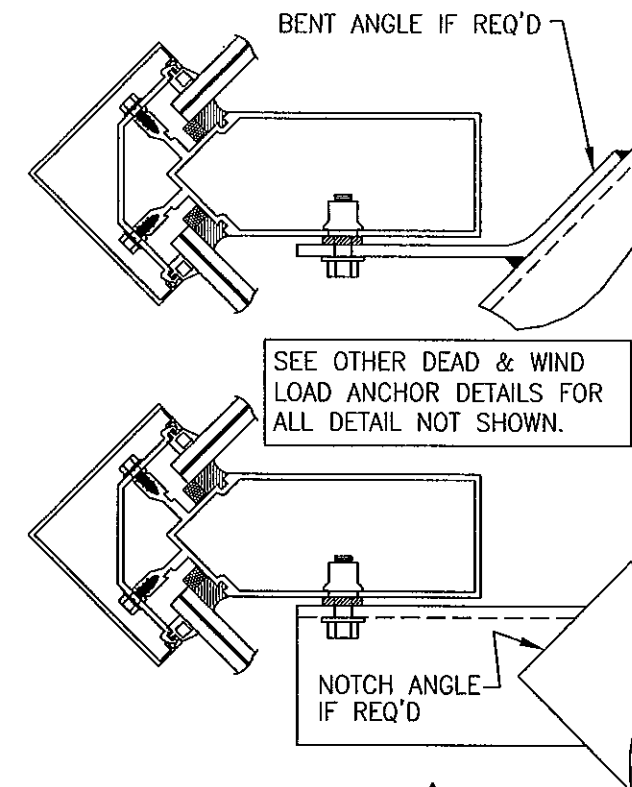
PROFESSIONAL
STATE OF FLORIDA
LICENSE
No. 44135
WARREN W. SCHAEFER, P.E.
P.E. NO. 44135

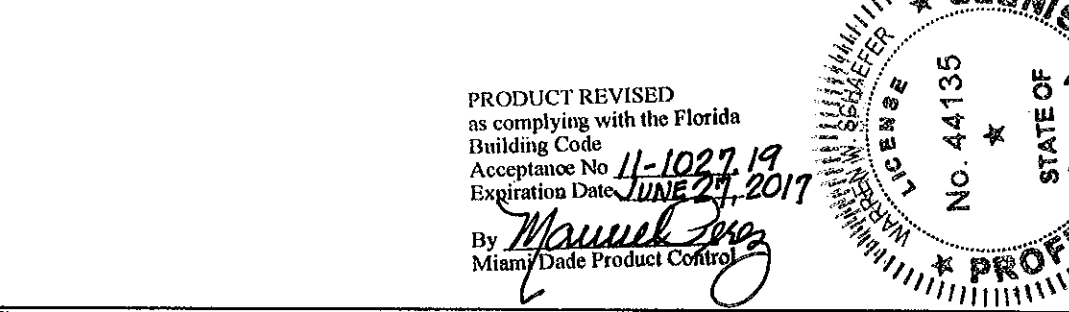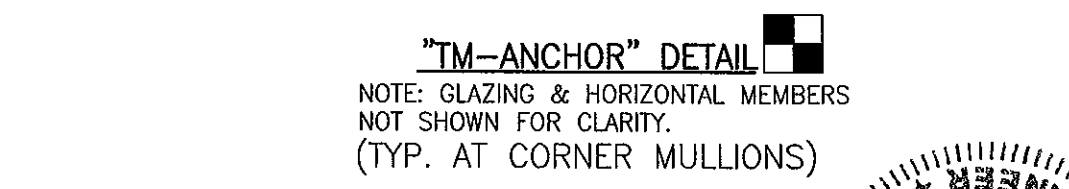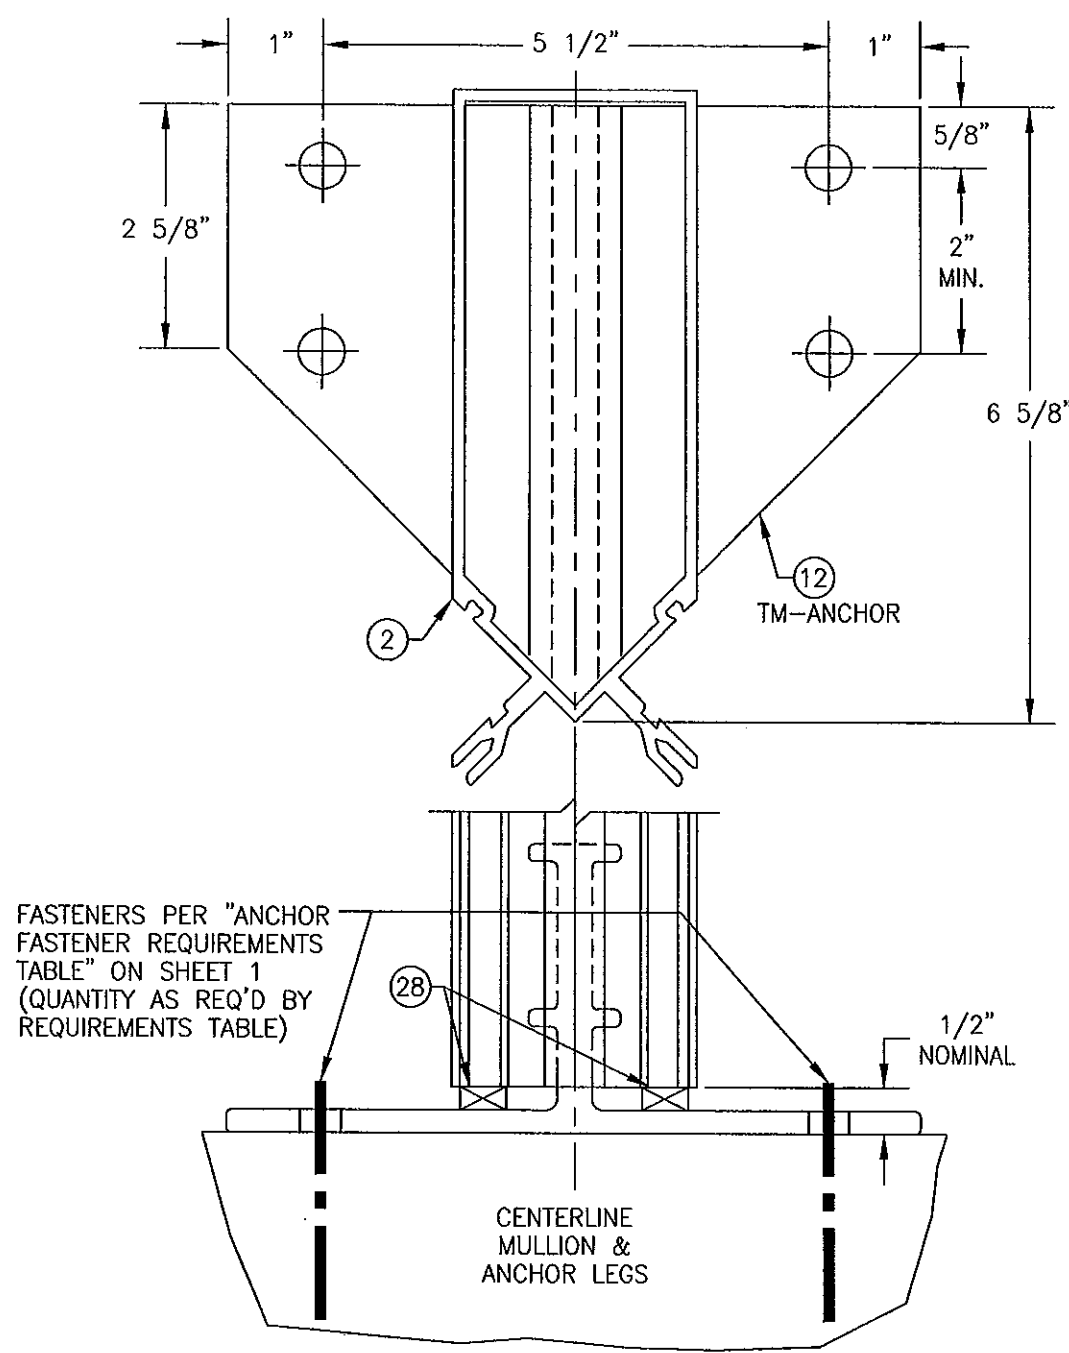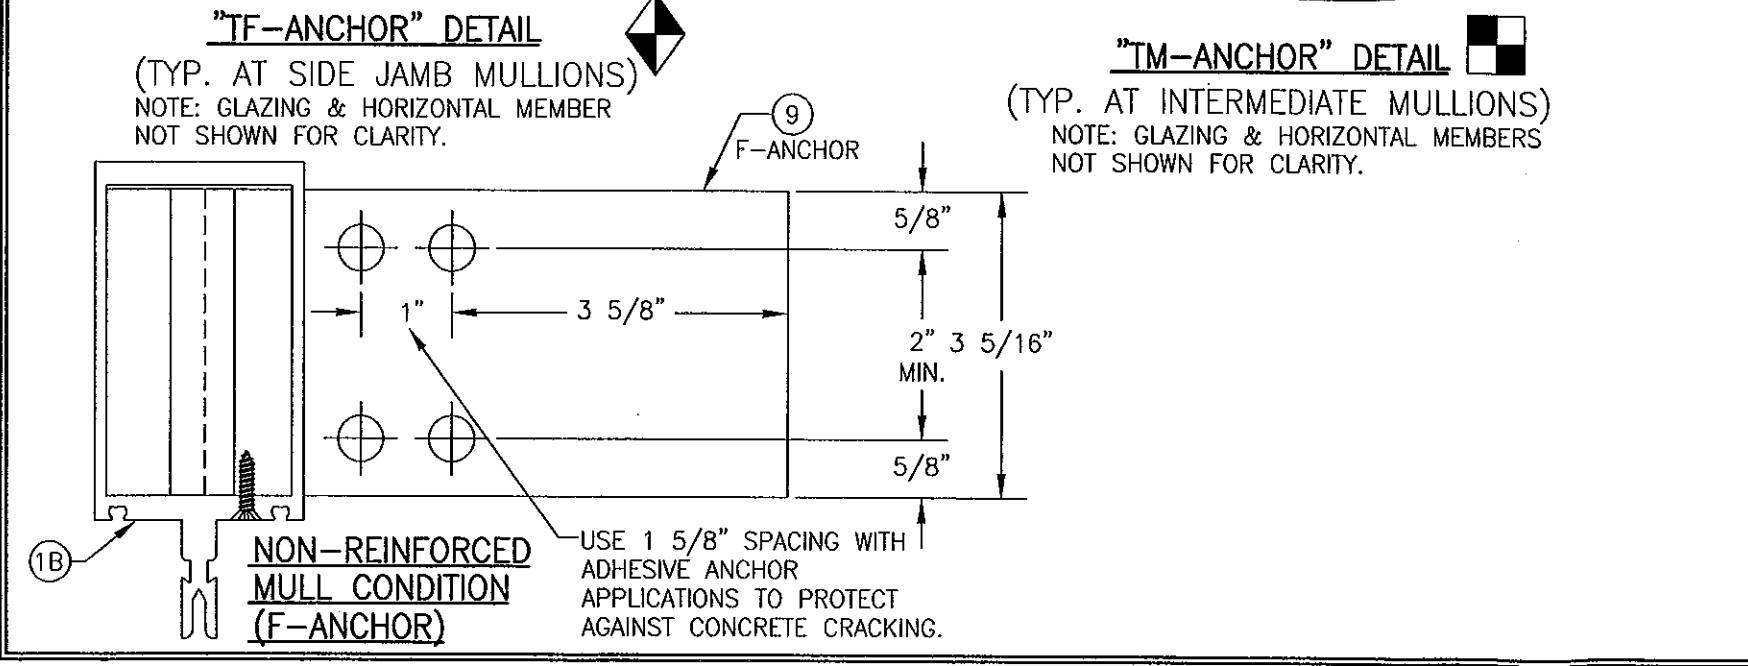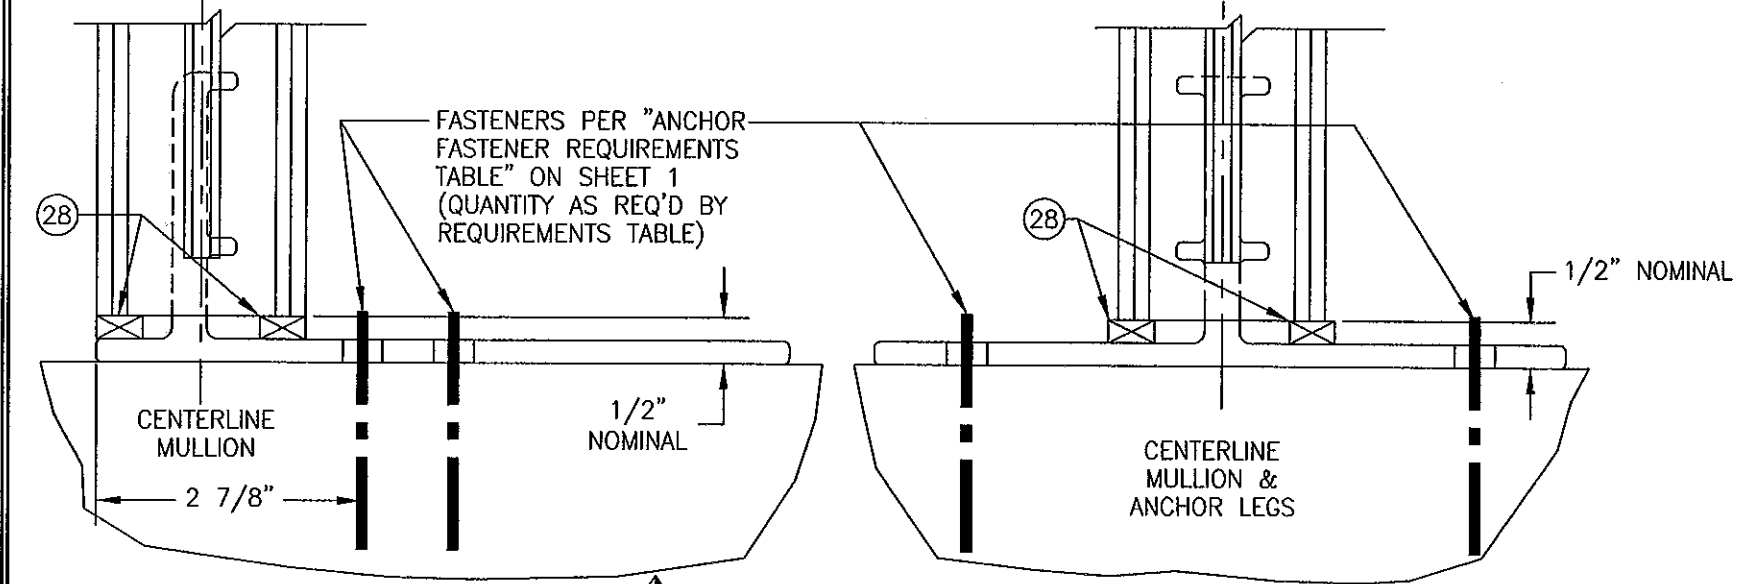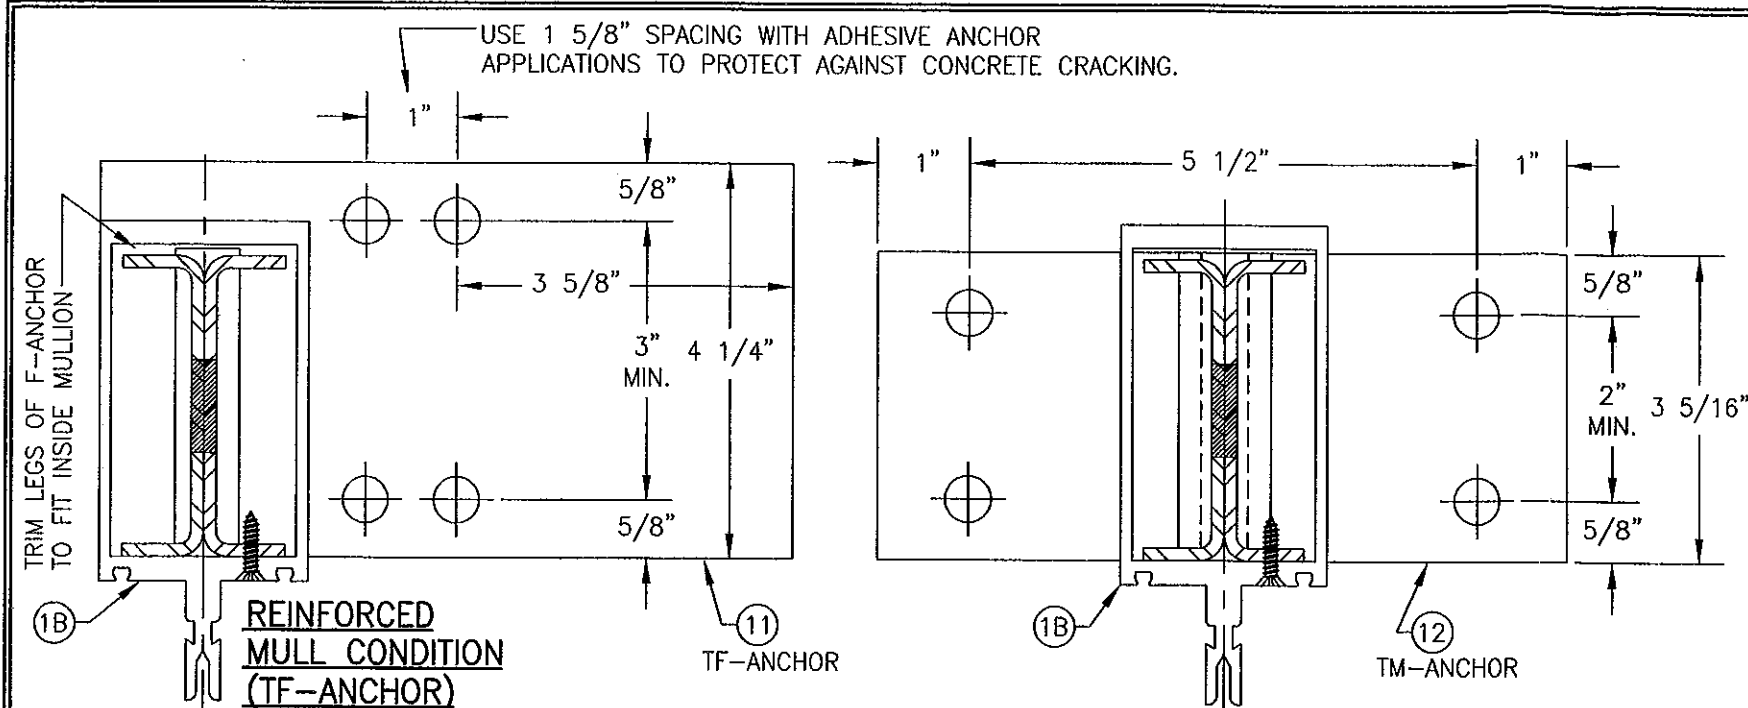


DEAD LOAD & WIND LOAD ANCHOR DETAIL
(TYP. AT JAMB MULLIONS)
(WIND LOAD ANCHOR HAS 1\"/>



EXTENDED DEAD LOAD & WIND LOAD ANCHOR DETAIL
(TYP. AT JAMB MULLIONS)
(WIND LOAD ANCHOR HAS 1\"/>




DEAD LOAD & WIND LOAD ANCHOR DETAIL
(TYP. AT CORNER MULLS)

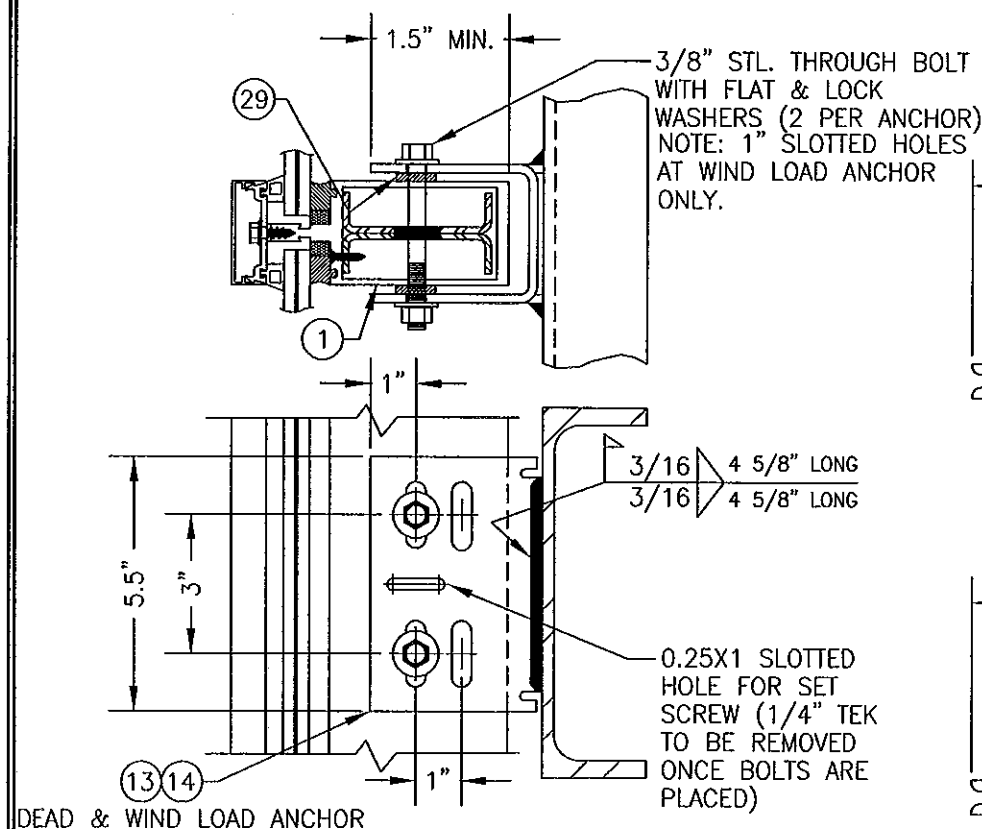


DEAD LOAD & WIND LOAD ANCHOR DETAIL
(TYP. AT INTERMEDIATE MULLIONS)
(WIND LOAD ANCHOR HAS 1\"/>


NOTE: DEAD LOAD & WIND LOAD ANCHOR DETAILS ARE SAME AT CORNER MULLION.

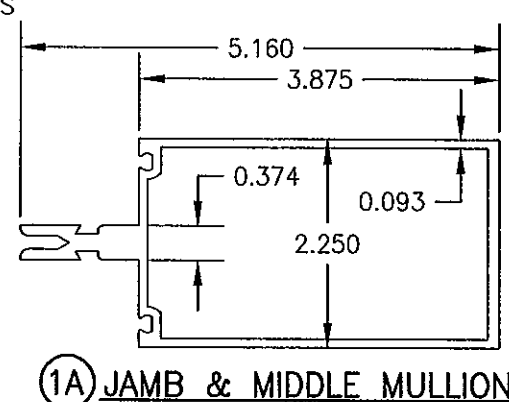


1A JAMB & MIDDLE MULLION

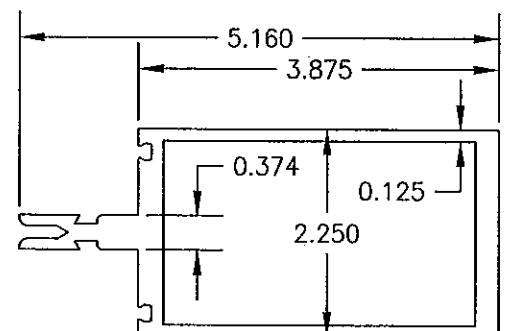


1B JAMB & MIDDLE MULLION

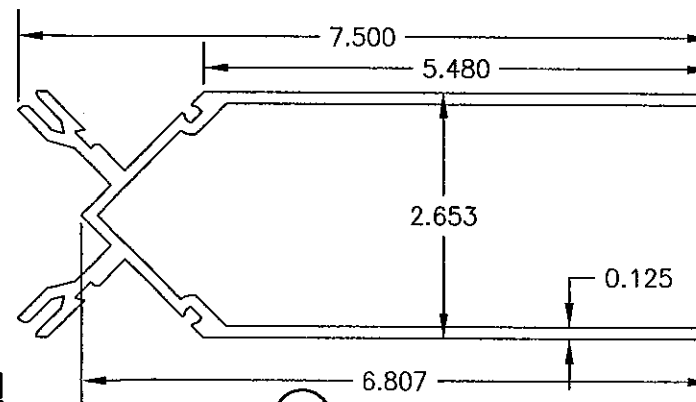


2 CORNER MULLION

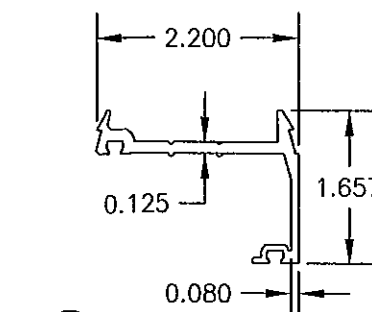

3 JAMB PRESSURE PLATE

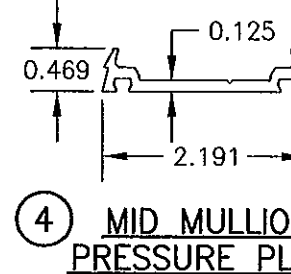


4 MID MULLION PRESSURE PLATE




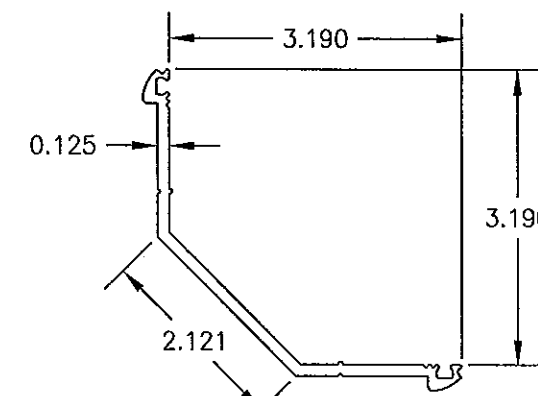


5 CORNER MULL PRESSURE PLATE

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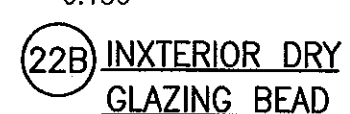

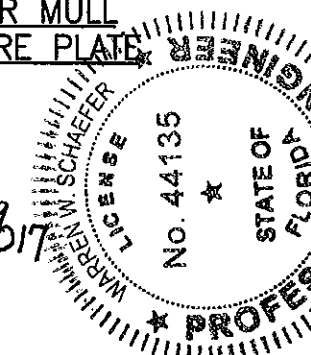
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PLOT: 1=2		DATE: 02/08/02	
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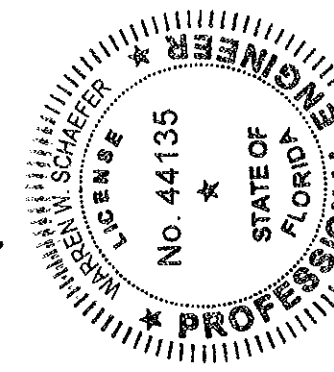


LENGTH = 3.438" @ MID & JAMB MULLS
& 5.687" @ CORNER MULLS (ENDS ARE
MITERED 45 DEG. AT CORNER MULLIONS)

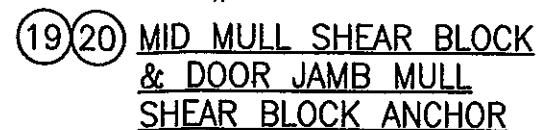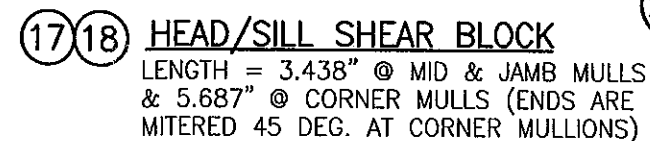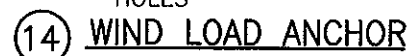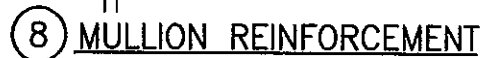0.150
(22A) EXTERIOR DRY
GLAZING BEAD



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<div style="float: left;"> <p>CERTIFICATION SEP 30 2011 WARREN W. SCHAEFER, P.E. P.E. NO. 44135</p> </div>			
DRAWING NO.	REV.		
1090	C		
SHEET NO.			
9 OF 9			